
# Definitive Conventional Subdivision Plans

June 10, 2016 (Revised January 9, 2017)

# Estates at Bull Meadow

North Grafton, Massachusetts 01536

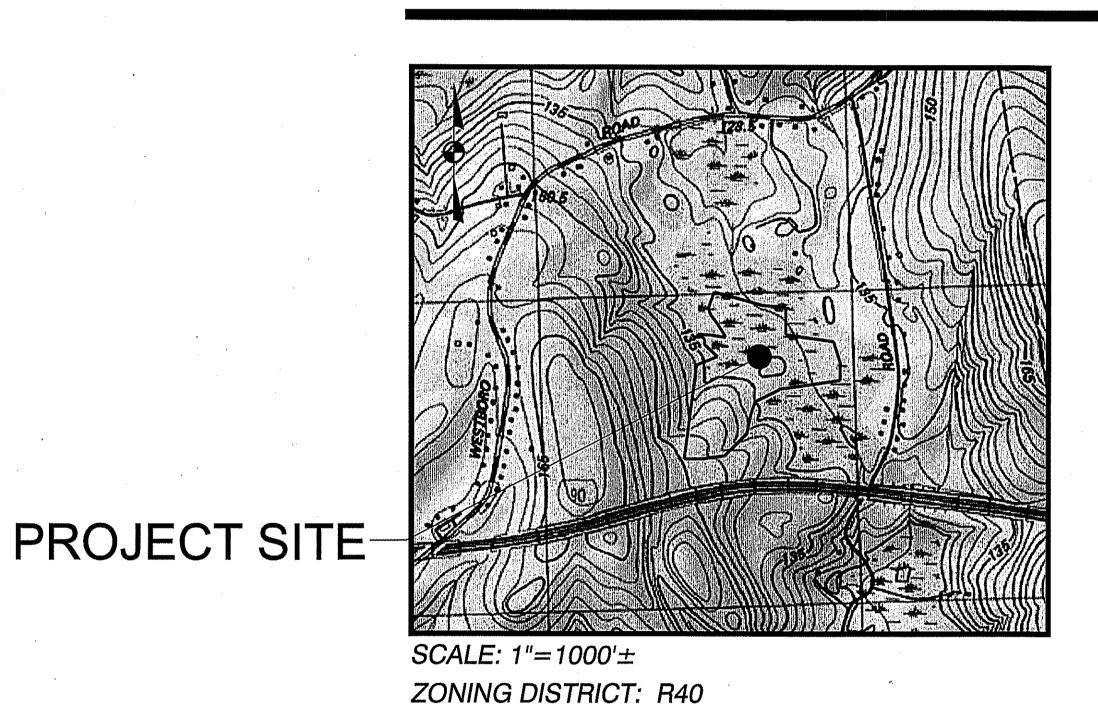

Applicant:
Bull Meadow, LLC.
2 Rachel Road
Boylston, MA 01505
(978)833-4747
Record Owner:
Bull Meadow, LLC.
Mr. Gordon Lewis, Manager
2 Rachel Road
Boylston, MA 01505
(978) 833-4747
Civil Engineer:
McCarty Engineering, Inc.
42 Jungle Road
Leominster, MA 01453


(978) 534-1318


Surveyor:
Whitman & Bingham Associates, LLC.
510 Mechanic Street
Leominster, MA 01453
(978) 537-5296
Wetland Consultant:
EcoTec, Inc.
102 Grove Street
Worcester, MA 01605
(508)752-9494




## Sheet Sheet Title

	Cover Sheet						
1	Existing Conditions Survey (1 of 2)	9	Layout and Materials Plan (3 of 3)	17	Roadway and Utility Profiles (4 of 4)	25	Construction Details (3 of 4)
2	Existing Conditions Survey (2 of 2)	10	Grading and Drainage Plan (1 of 2)	18	Water Main Extension Plan	26	Construction Details (4 of 4)
3	Lotting Plan (1 of 4)	11	Grading and Drainage Plan (2 of 2)	19	Erosion Control Plan (1 of 2)	27	Stormtech Detail Sheet
4	Lotting Plan (2 of 4)	12	Utility Plan (1 of 2)	20	Erosion Control Plan (2 of 2)	28	O&M Plan
5	Lotting Plan (3 of 4)	13	Utility Plan (2 of 2)	21	Wetland Crossing and Replication Plan	29	Conditions of Approval
6	Lotting Plan (4 of 4)	14	Roadway and Utility Profiles (1 of 4)	22	Construction Phasing Plan		
7	Overall Subdivision Plan (1 of 3)	15	Roadway and Utility Profiles (2 of 4)	23	Construction Details (1 of 4)		
8	Layout and Materials Plan (2 of 3)	16	Roadway and Utility Profiles (3 of 4)	24	Construction Details (2 of 4)		

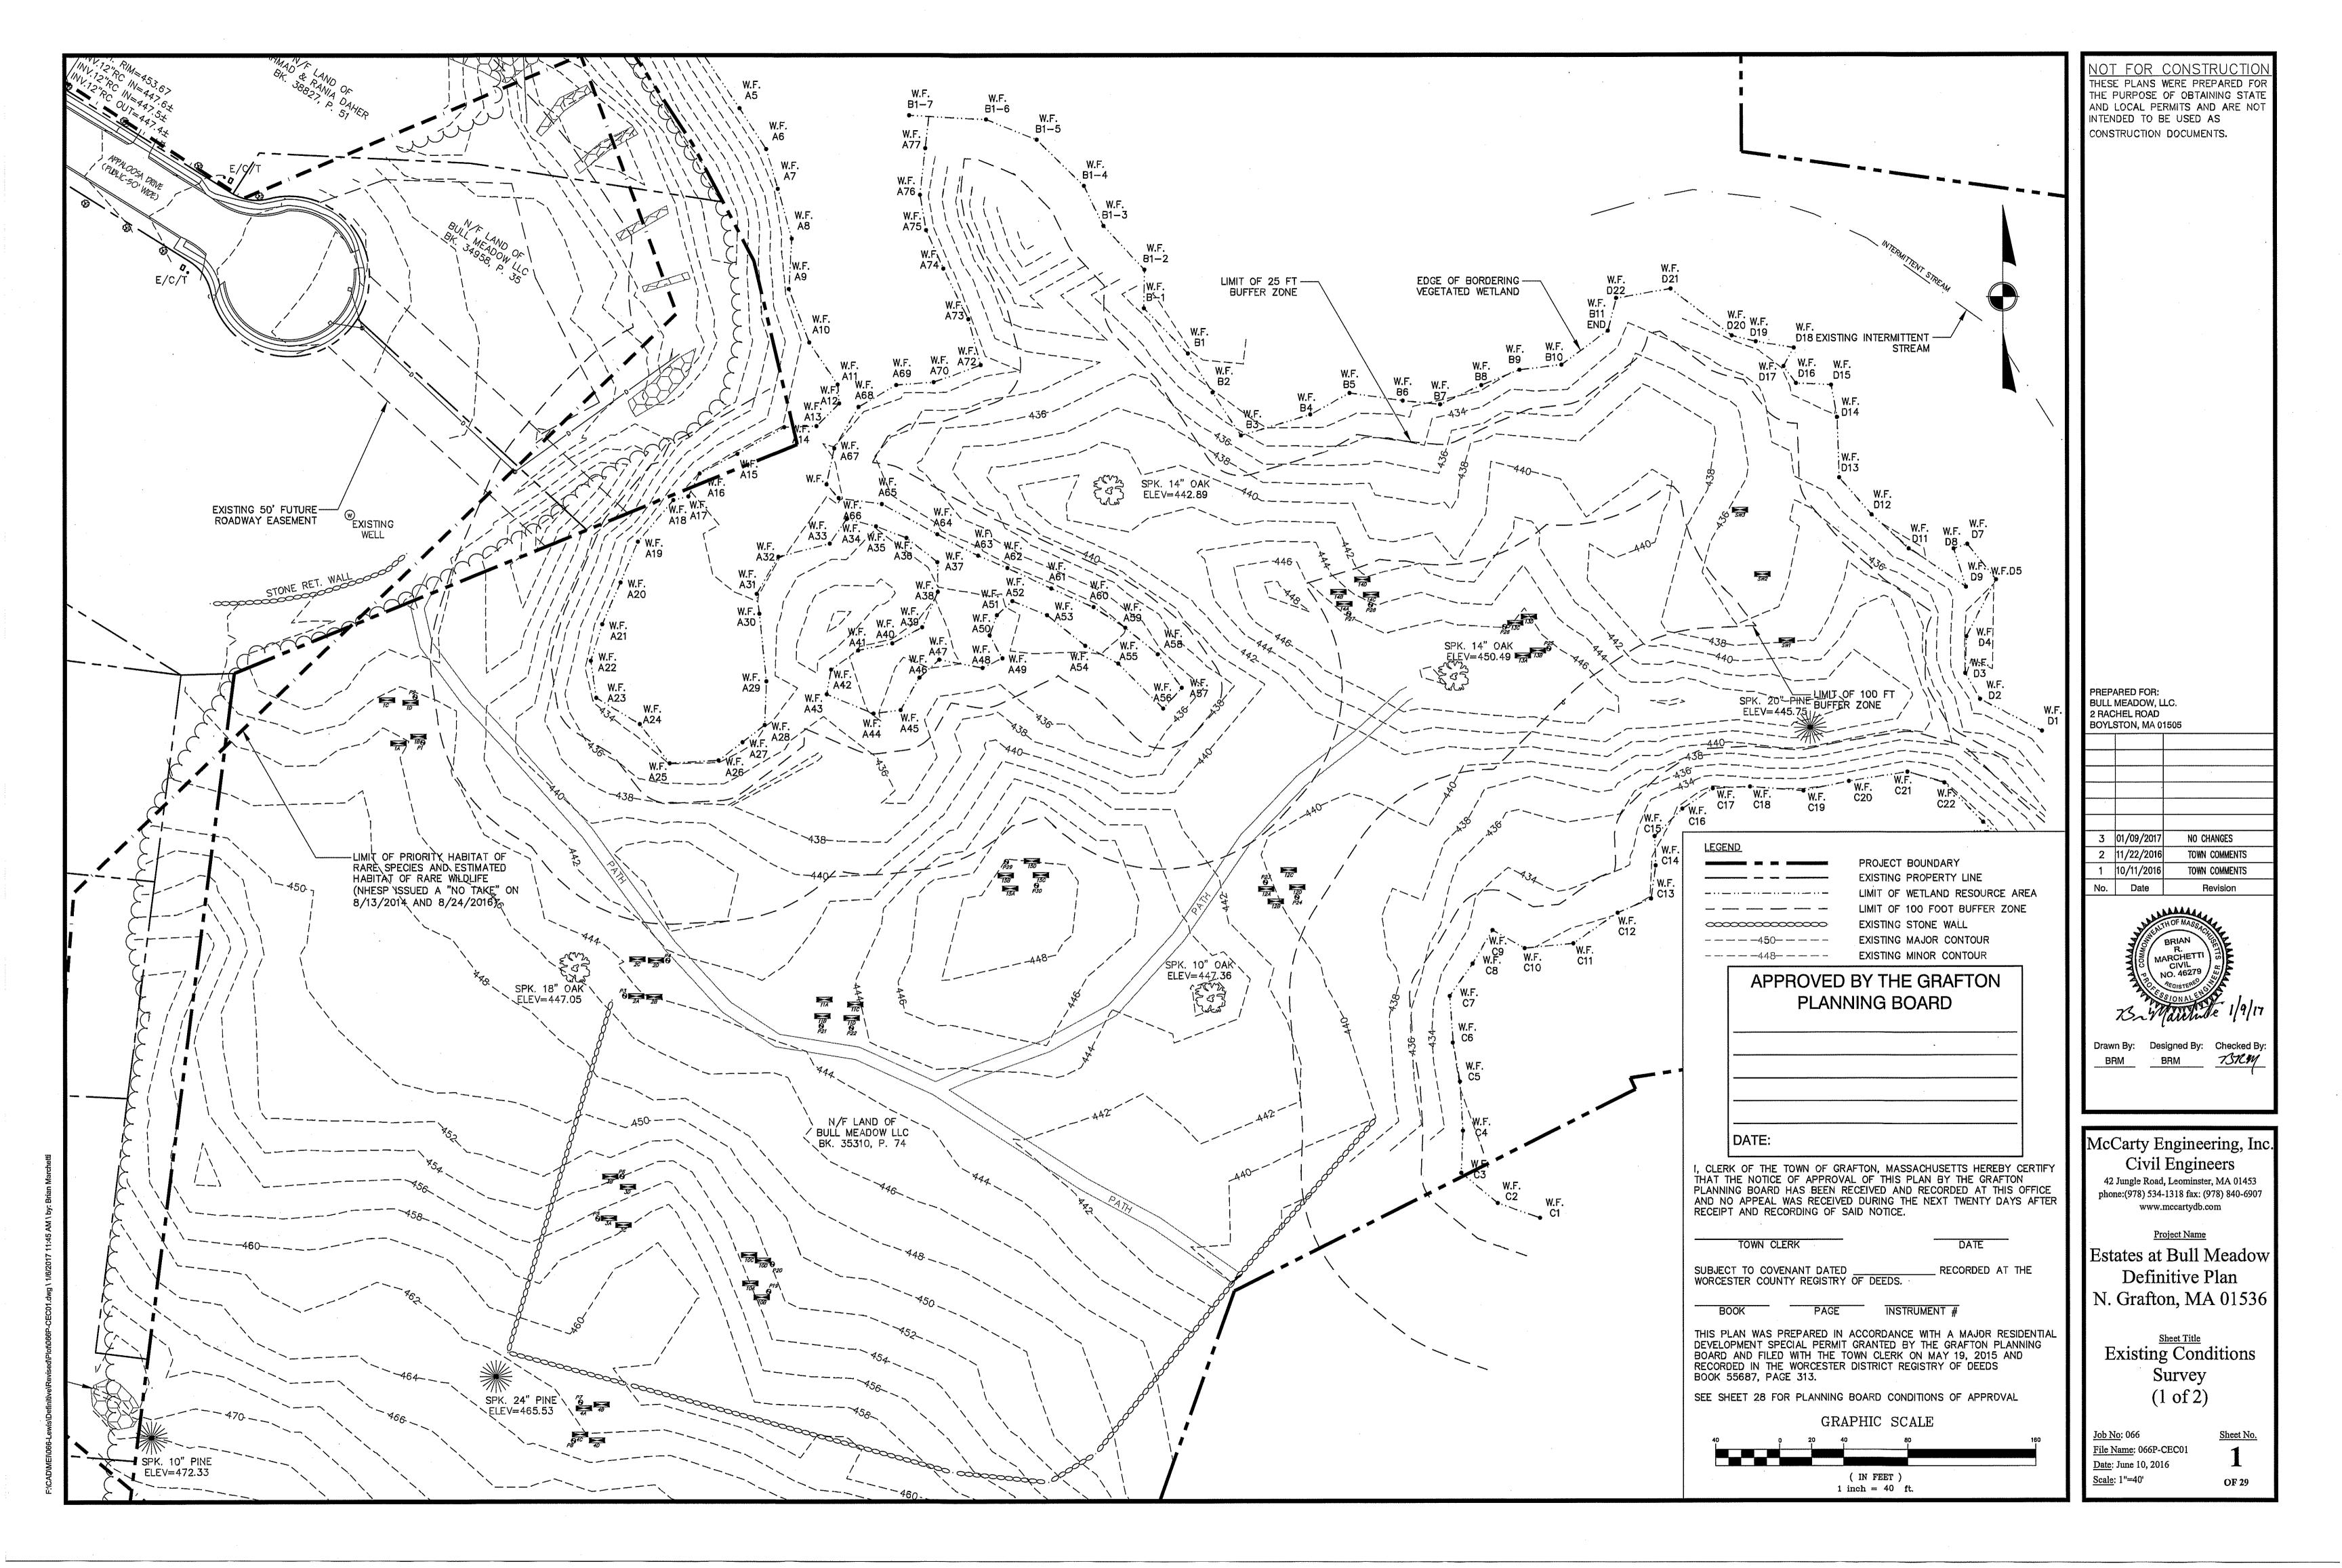

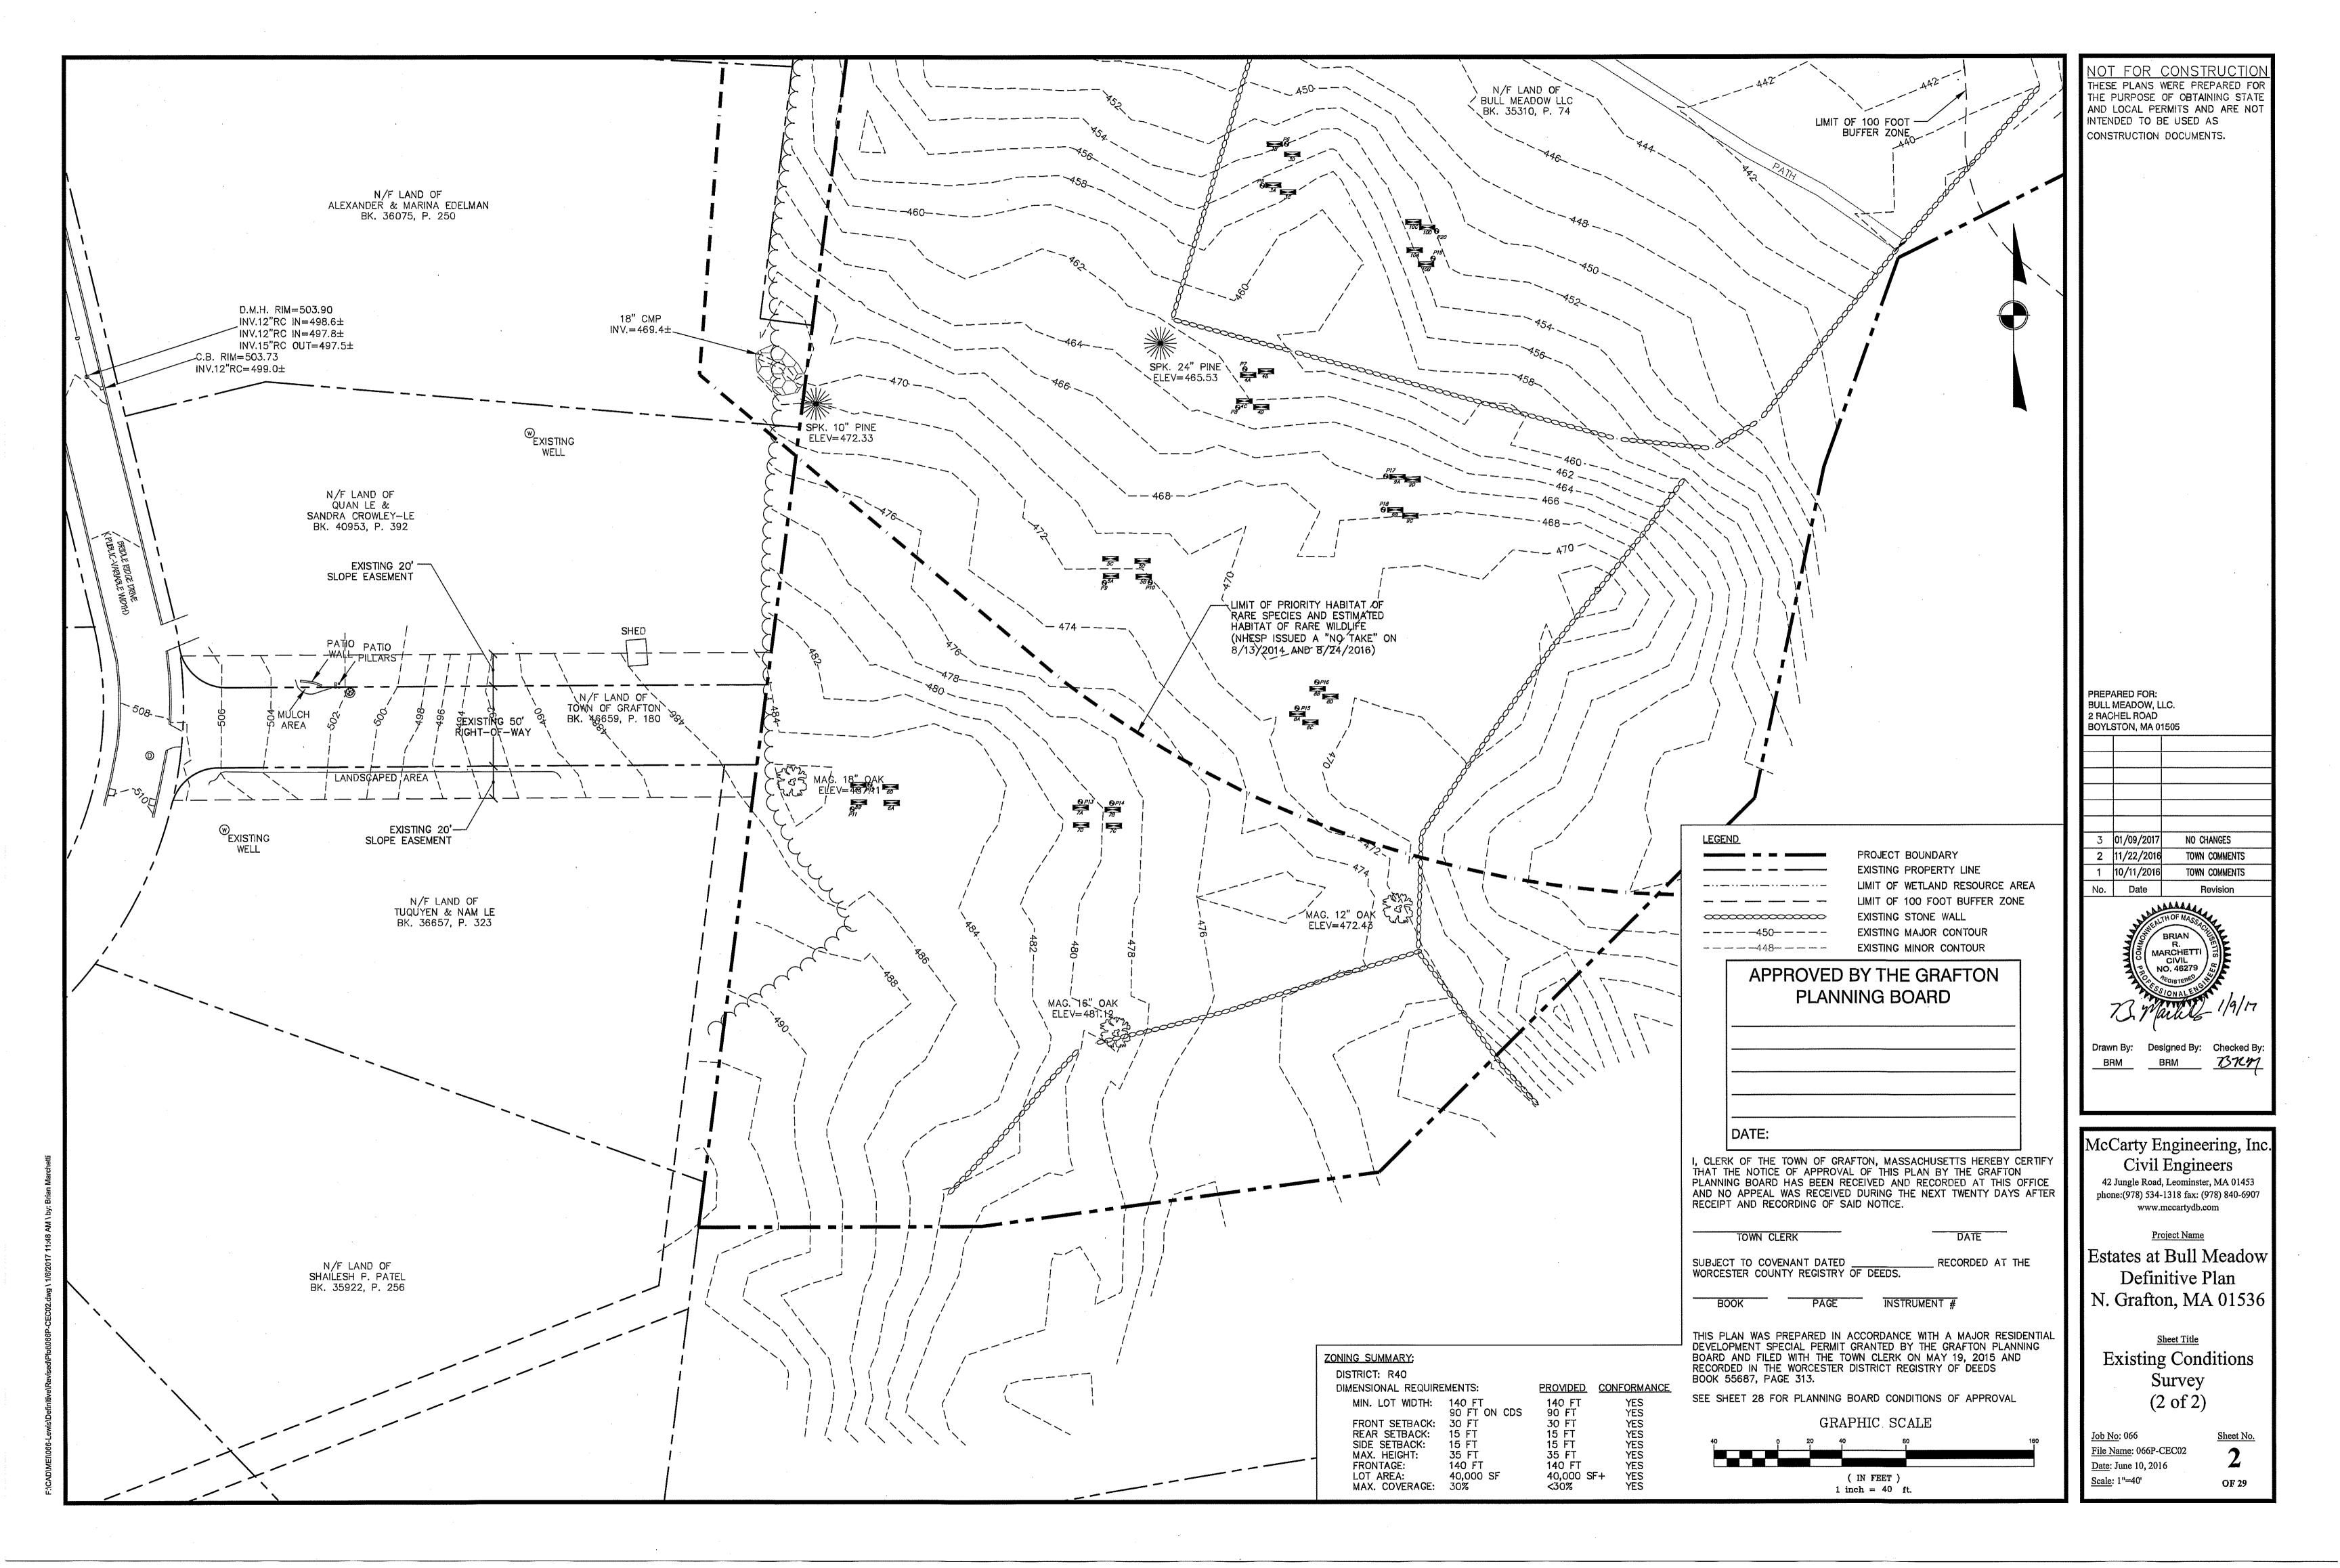

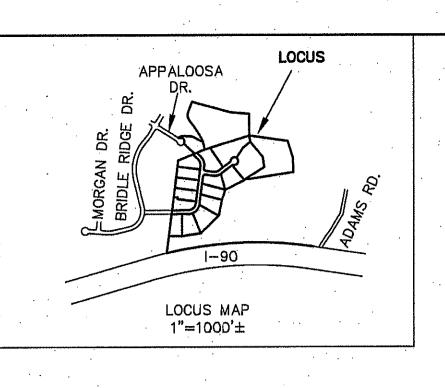

APPROVED	BY	THE	GRAFTON	
PLANNING	ВОА	RD DA	\TE:	
				<i>.</i>
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		• ,		
	**************************************	, , , , , , , , , , , , , , , , , , ,		

1. OWNER/APPLICANT: BULL MEADOW, LLC BK. 53605, P. 383 BK. 35310, P. 74 BK. 34958, P. 35

2. PLAN REFERENCES: P.B. 750, P. 55 P.B. 784, P. 109 P.B. 799, P. 108 P.B. 911, P. 97

3. THE SUBJECT PREMISES IS GRAPHICALLY SITUATED IN THE R-4D ZONING DISTRICT WITH THE FOLLOWING MIMINUM DIMENSIONAL REQUIREMENTS:

MINIMUM LOT AREA: 40,000 S.F. MINIMUM LOT FRONTAGE: 140 FT. MINIMUM FRONT SETBACK: 30 FT. MINIMUM SIDE SETBACK: 15 FT. MINIMUM REAR SETBACK: 15 FT.

4. THE SUBJECT PREMISES IS NOT GRAPHICALLY SITUATED IN THE 100-YEAR FLOOD HAZARD ZONE PER FLOOD INSURANCE RATE MAPS 25027CD831F AND 25027C0832F DATED JULY 16, 2014.

5. OPEN SPACE PARCELS A AND B ARE NOT TO BE CONSIDERED BUILDING LOTS, NO FURTHER BUILDING MAY OCCUR WITHOUT FURTHER APPROVAL BY THE PLANNING BOARD PURSUANT TO THE SUBDIVISION CONTROL LAW.

6. SEE SHEET 28 FOR PLANNING BOARD CONDITIONS OF APPROVAL.

DENOTES GRANITE BOUND TO BE SET

I HEREBY CERTIFY THAT NO NOTICE OF APPEALS WAS RECEIVED DURING THE TWENTY DAYS NEXT AFTER THE RECEIPT AND RECORDING OF THE NOTICE FROM THE GRAFTON PLANNING BOARD OF THE APPROVAL OF THIS PLAN. DATE TOWN OF GRAFTON CLERK



ESTATES AT BULL MEADOW

DEFINITIVE SUBDIVISION PLAN OF LAND

IN GRAFTON, MA

PREPARED FOR

BULL MEADOW, LLC

JUNE 10, 2016

REVISED 10-11-16 REVISED 11-22-16

WHITMAN & BINGHAM ASSOCIATES, LLC REGISTERED PROFESSIONAL ENGINEERS & LAND SURVEYORS


510 MECHANIC STREET - LEOMINSTER, MASSACHUSETTS D1453


SHEET 3 OF 28


I CERTIFY THAT THIS PLAN MEETS WITH


REGULATIONS OF REGISTERS OF DEEDS

31--D--39

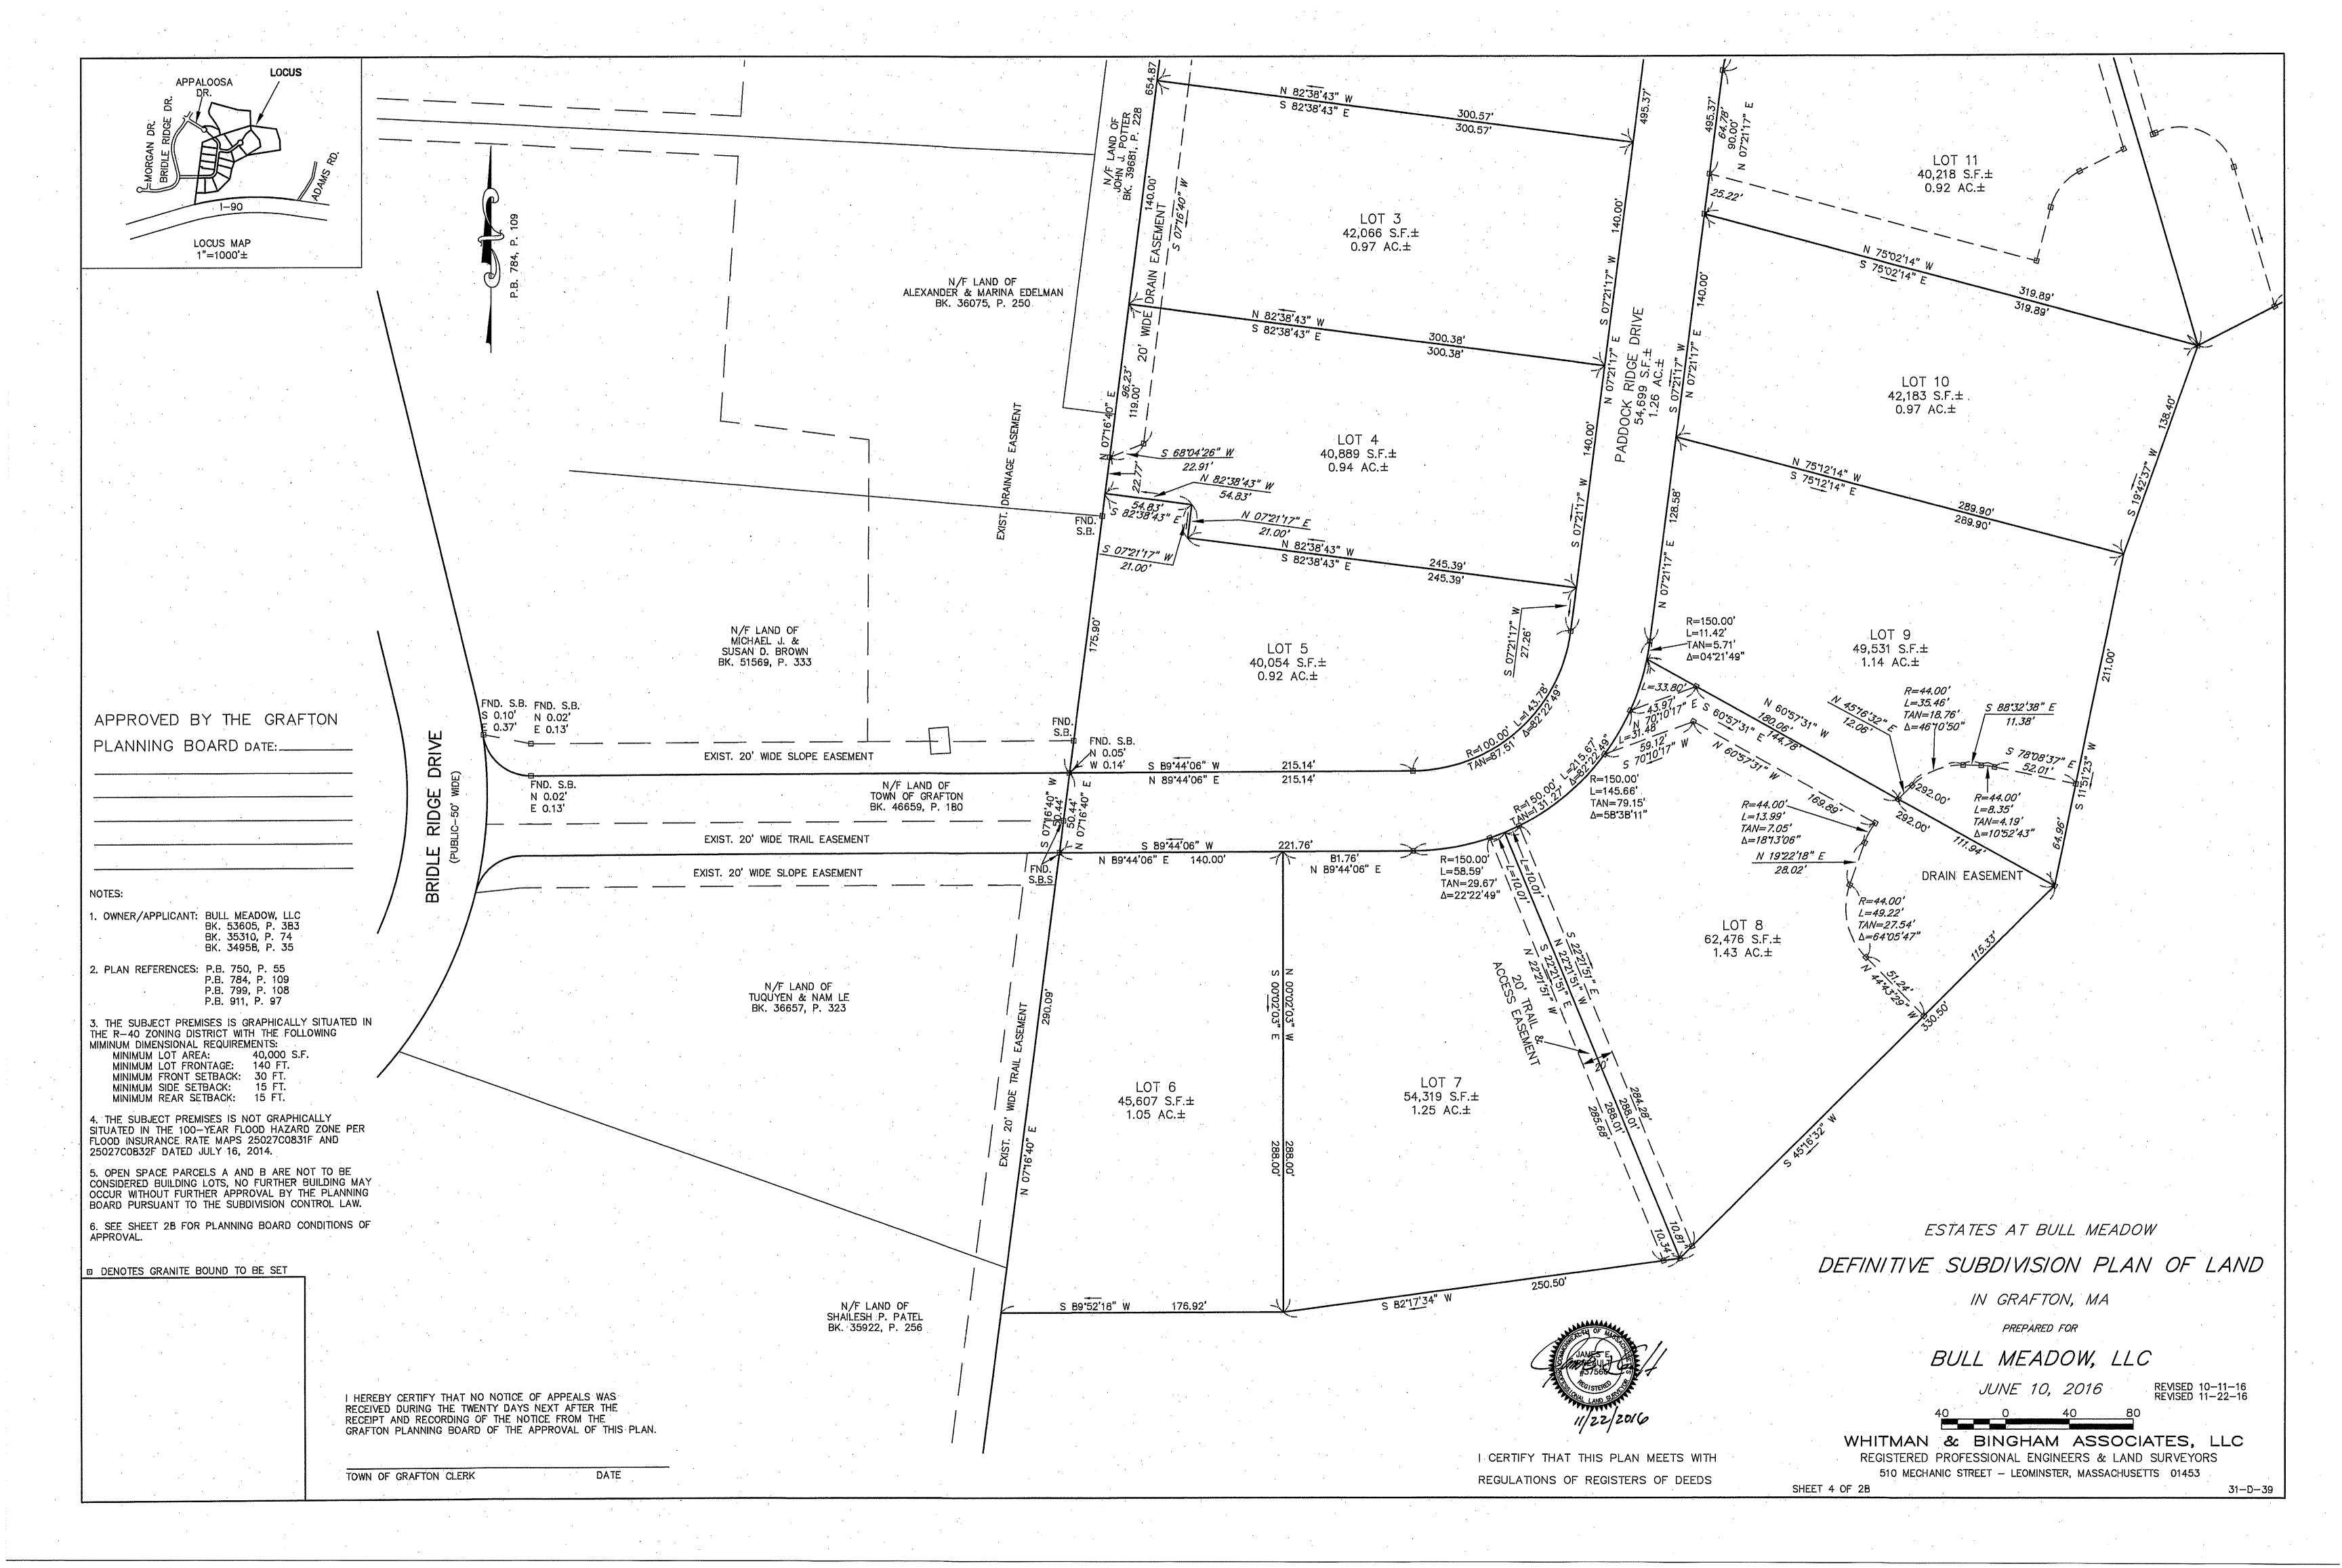

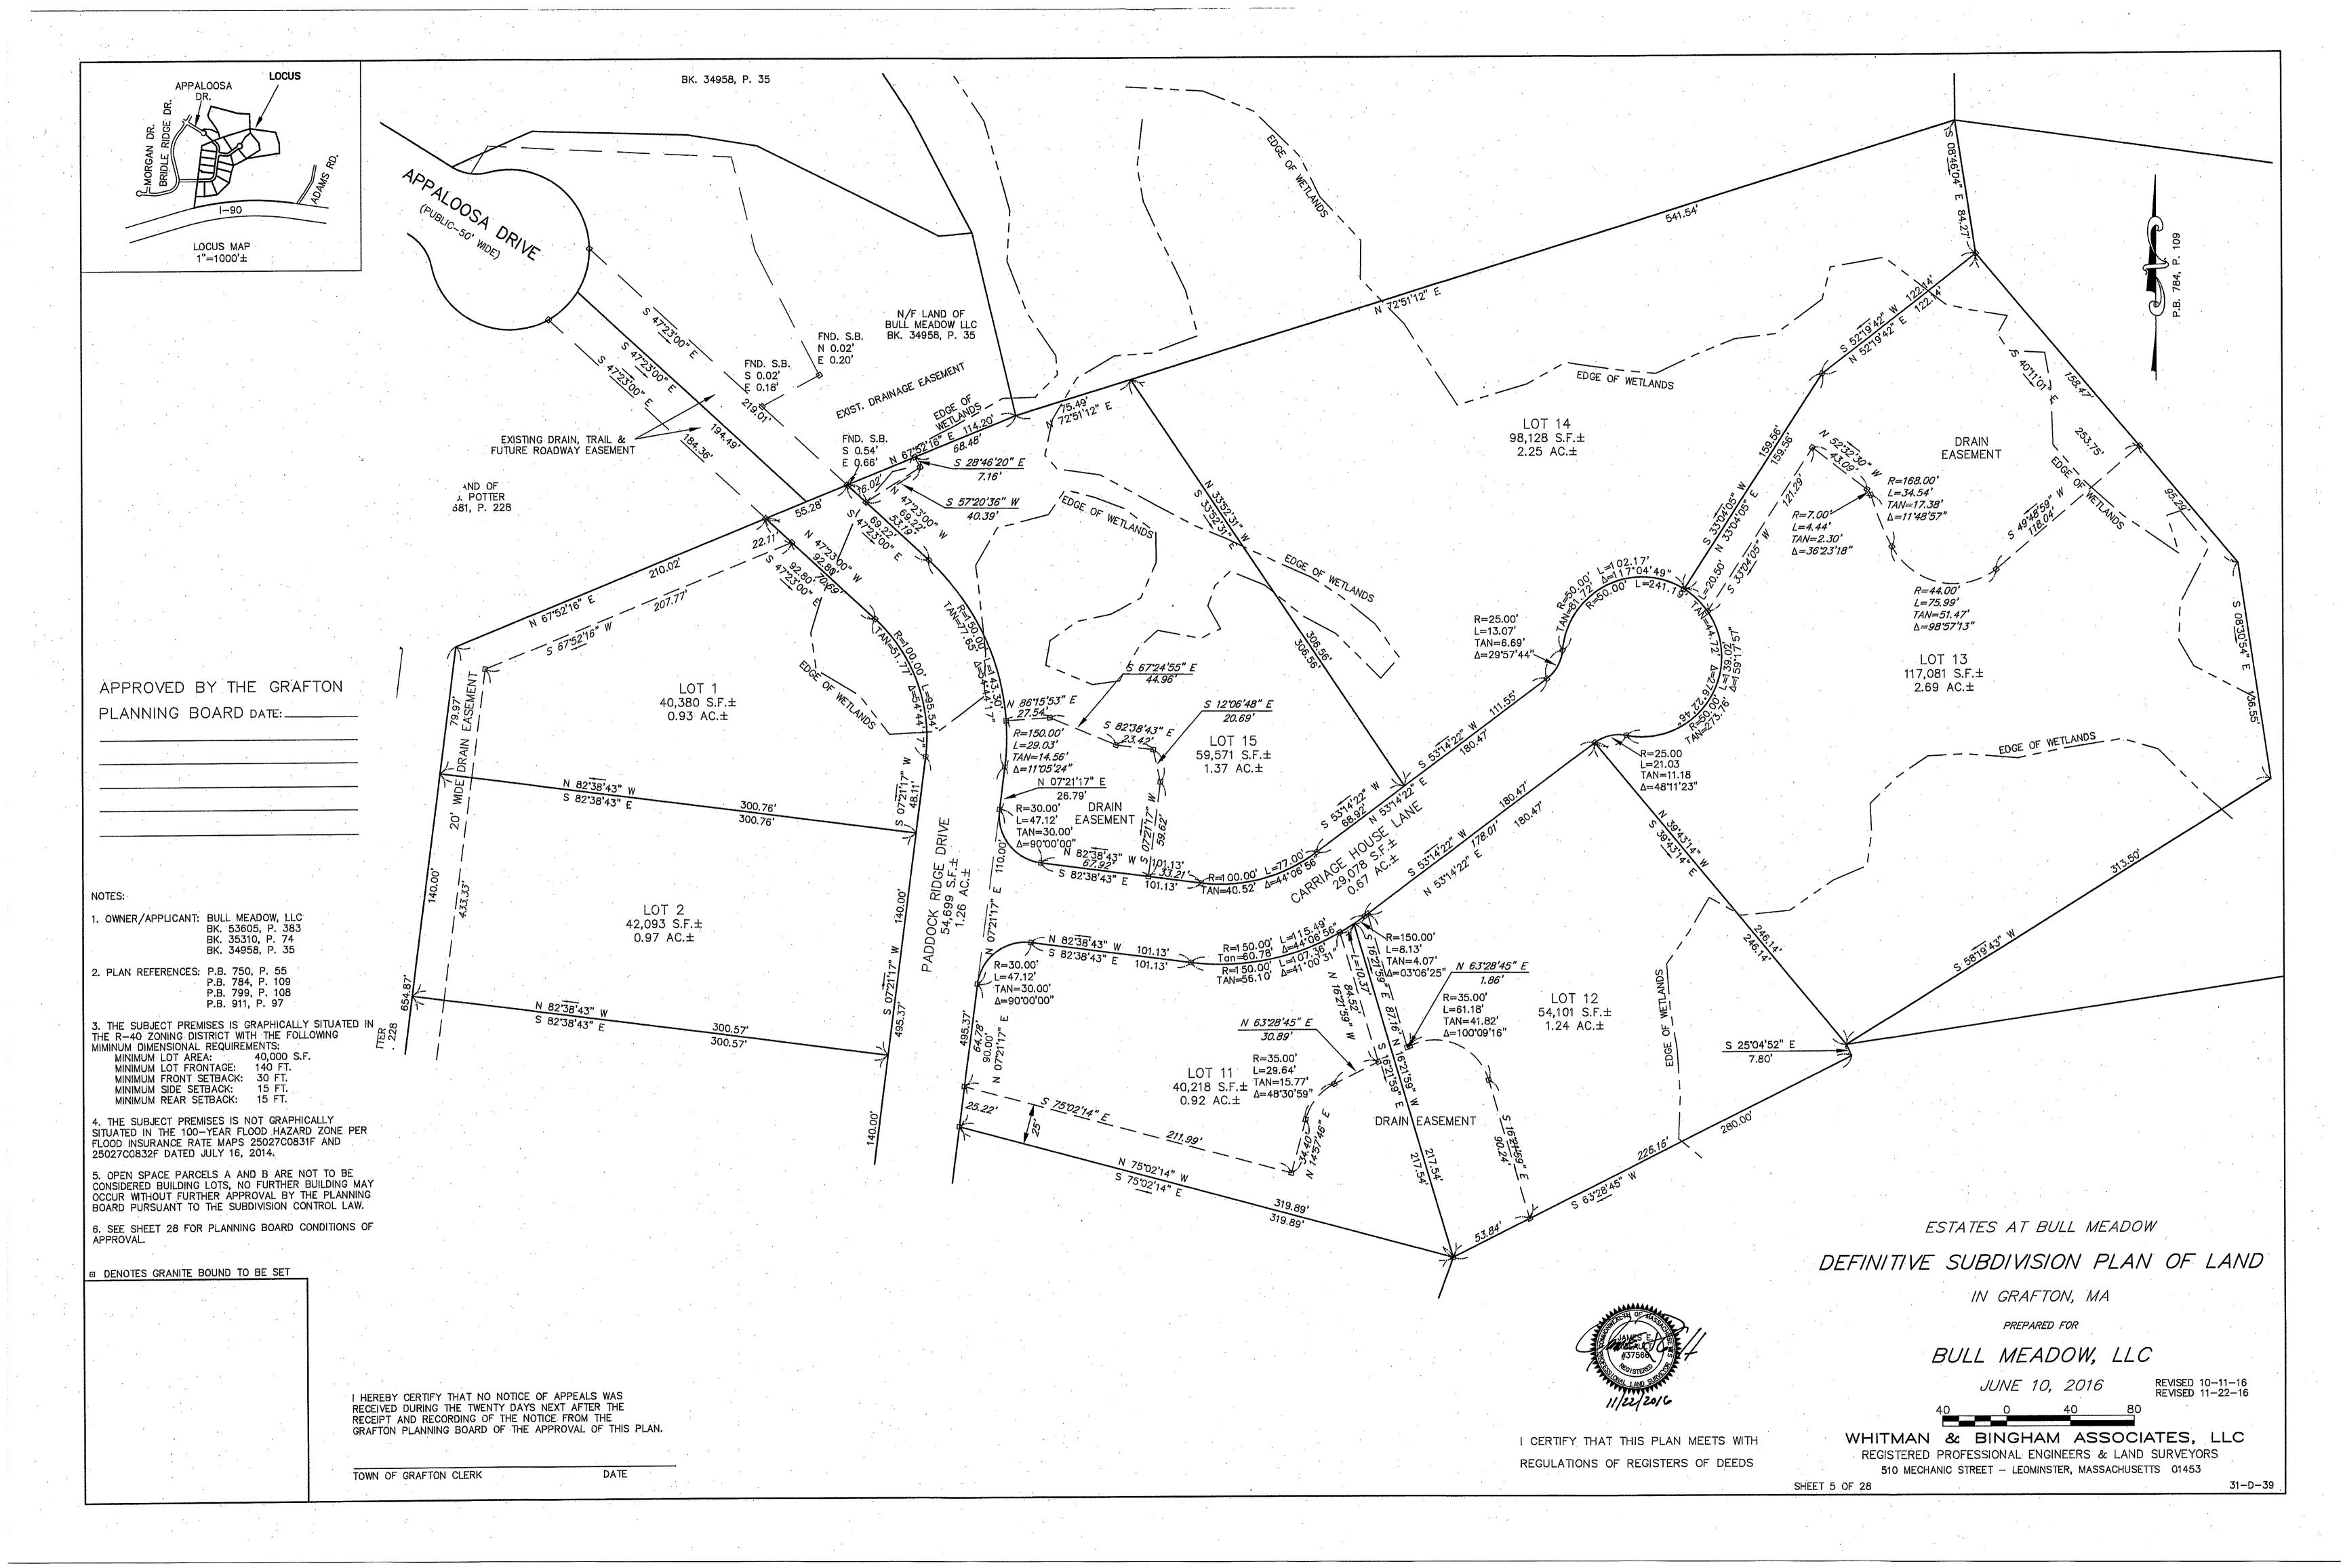

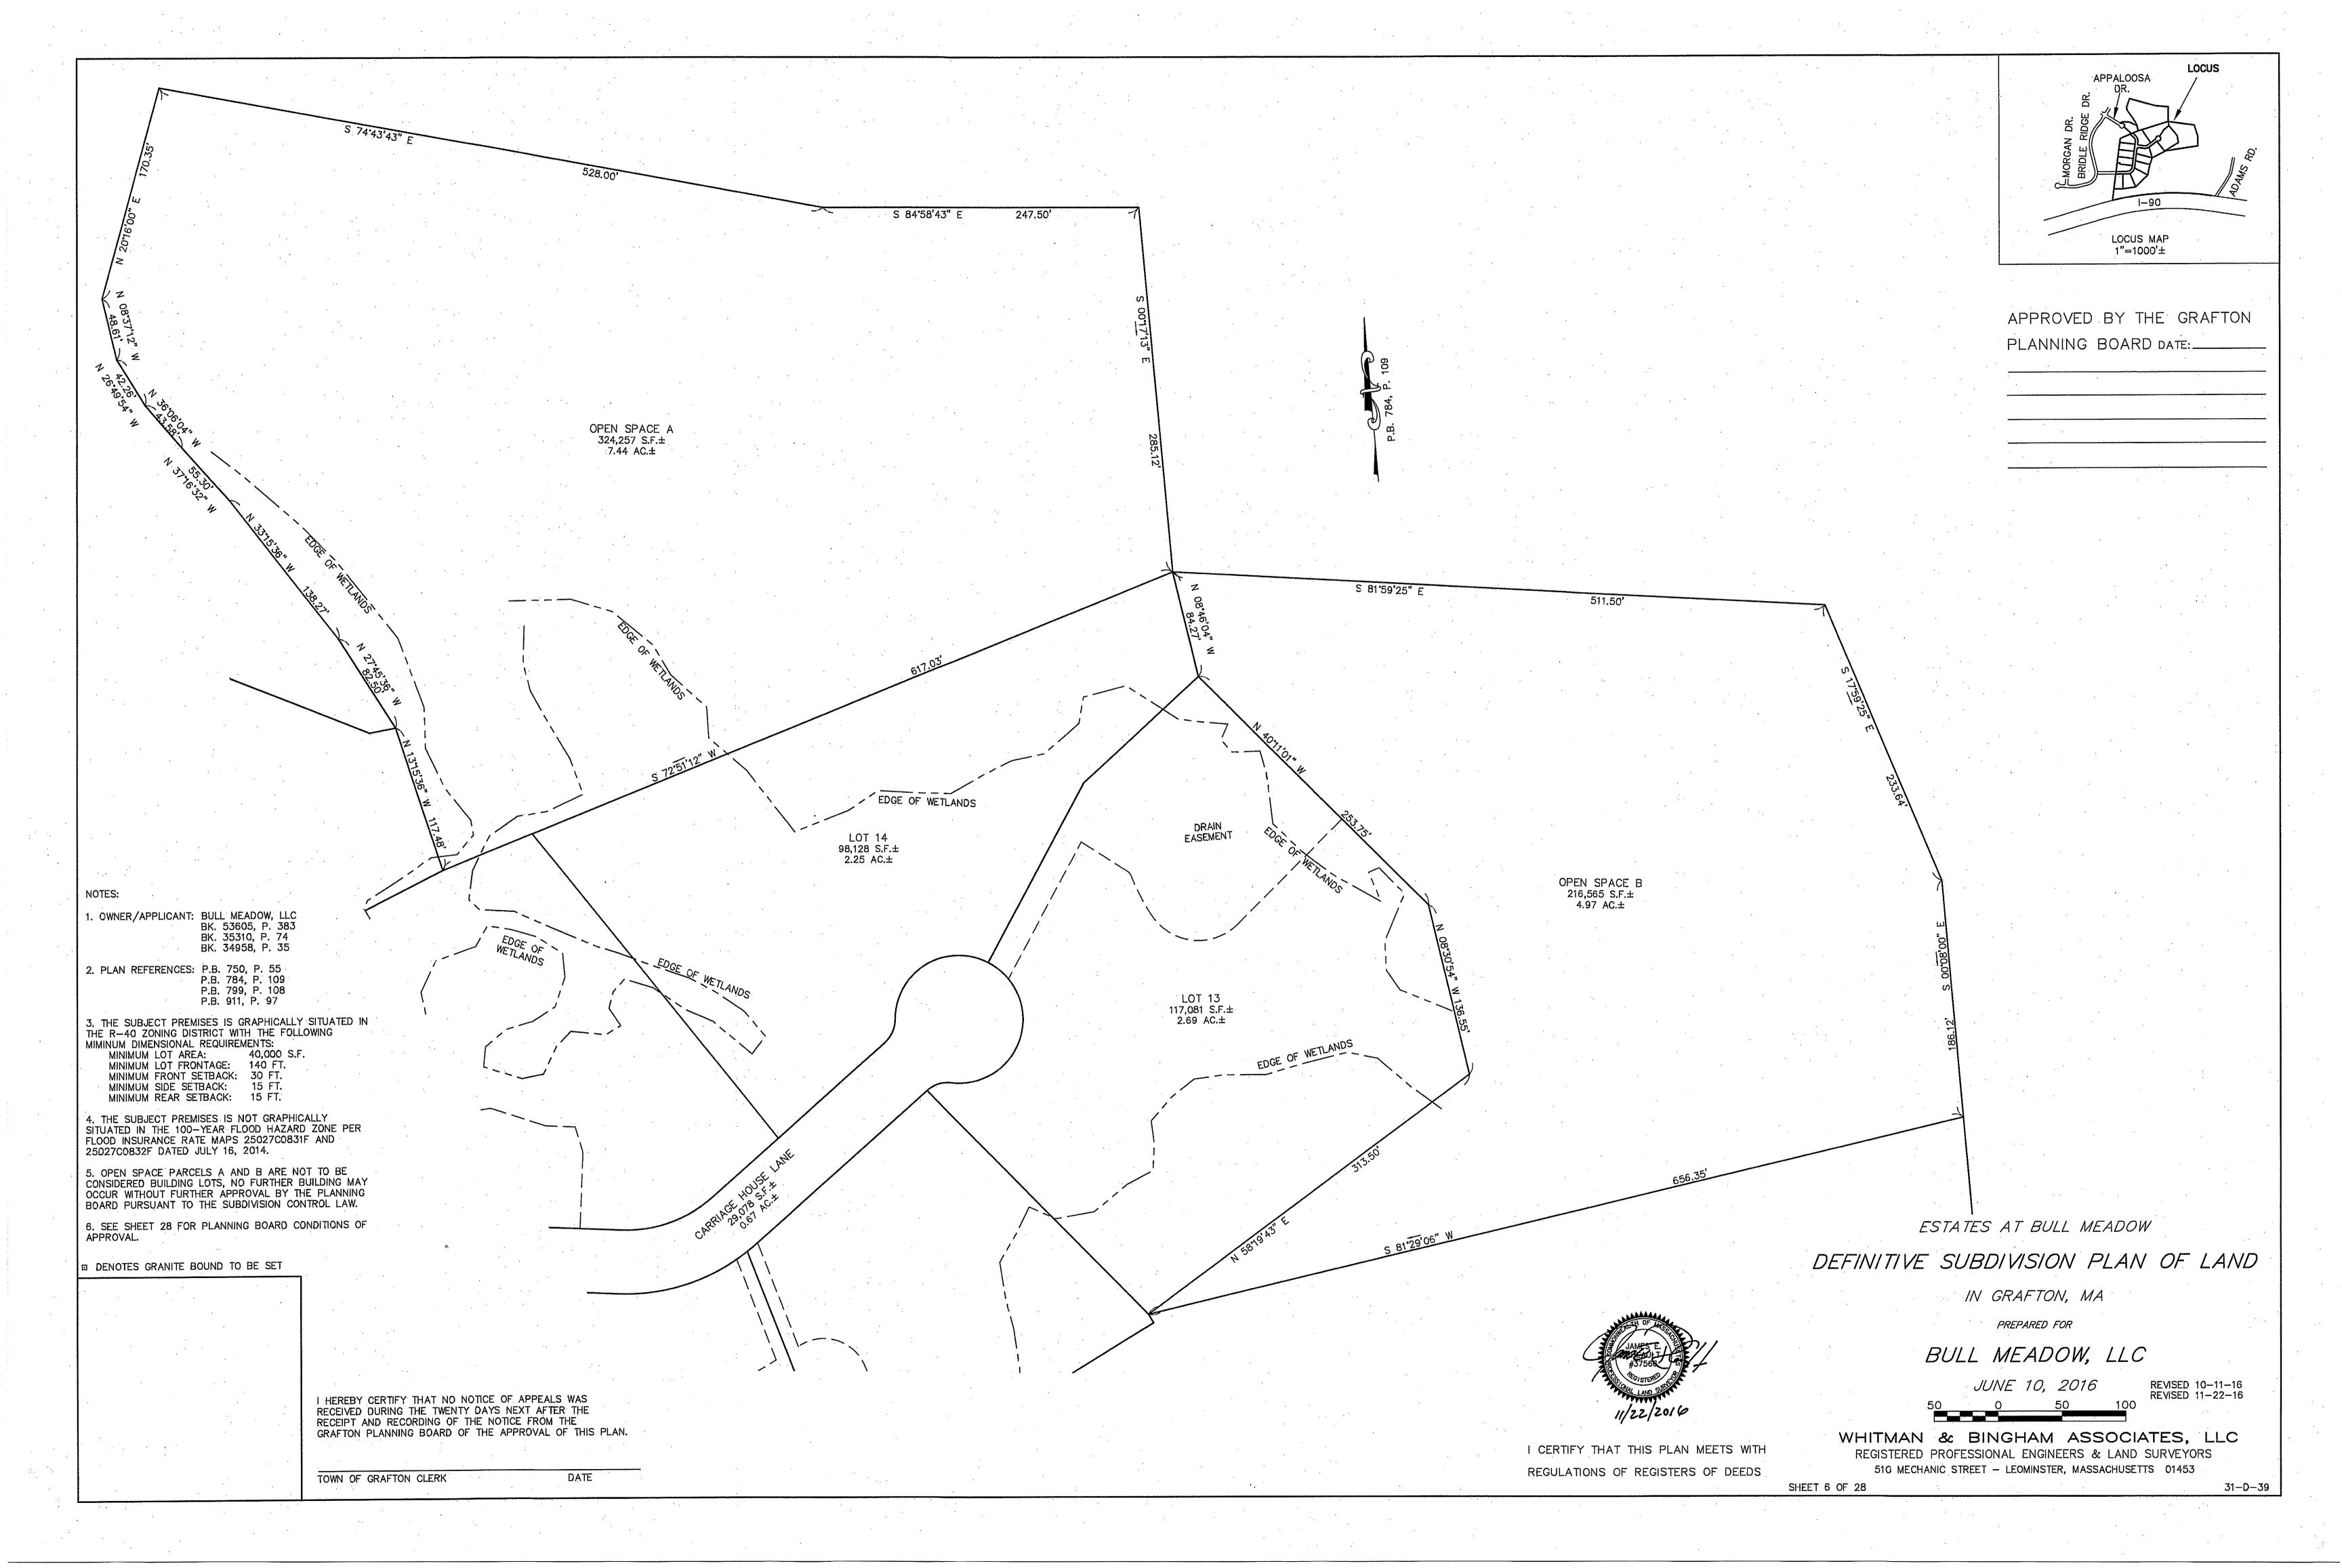

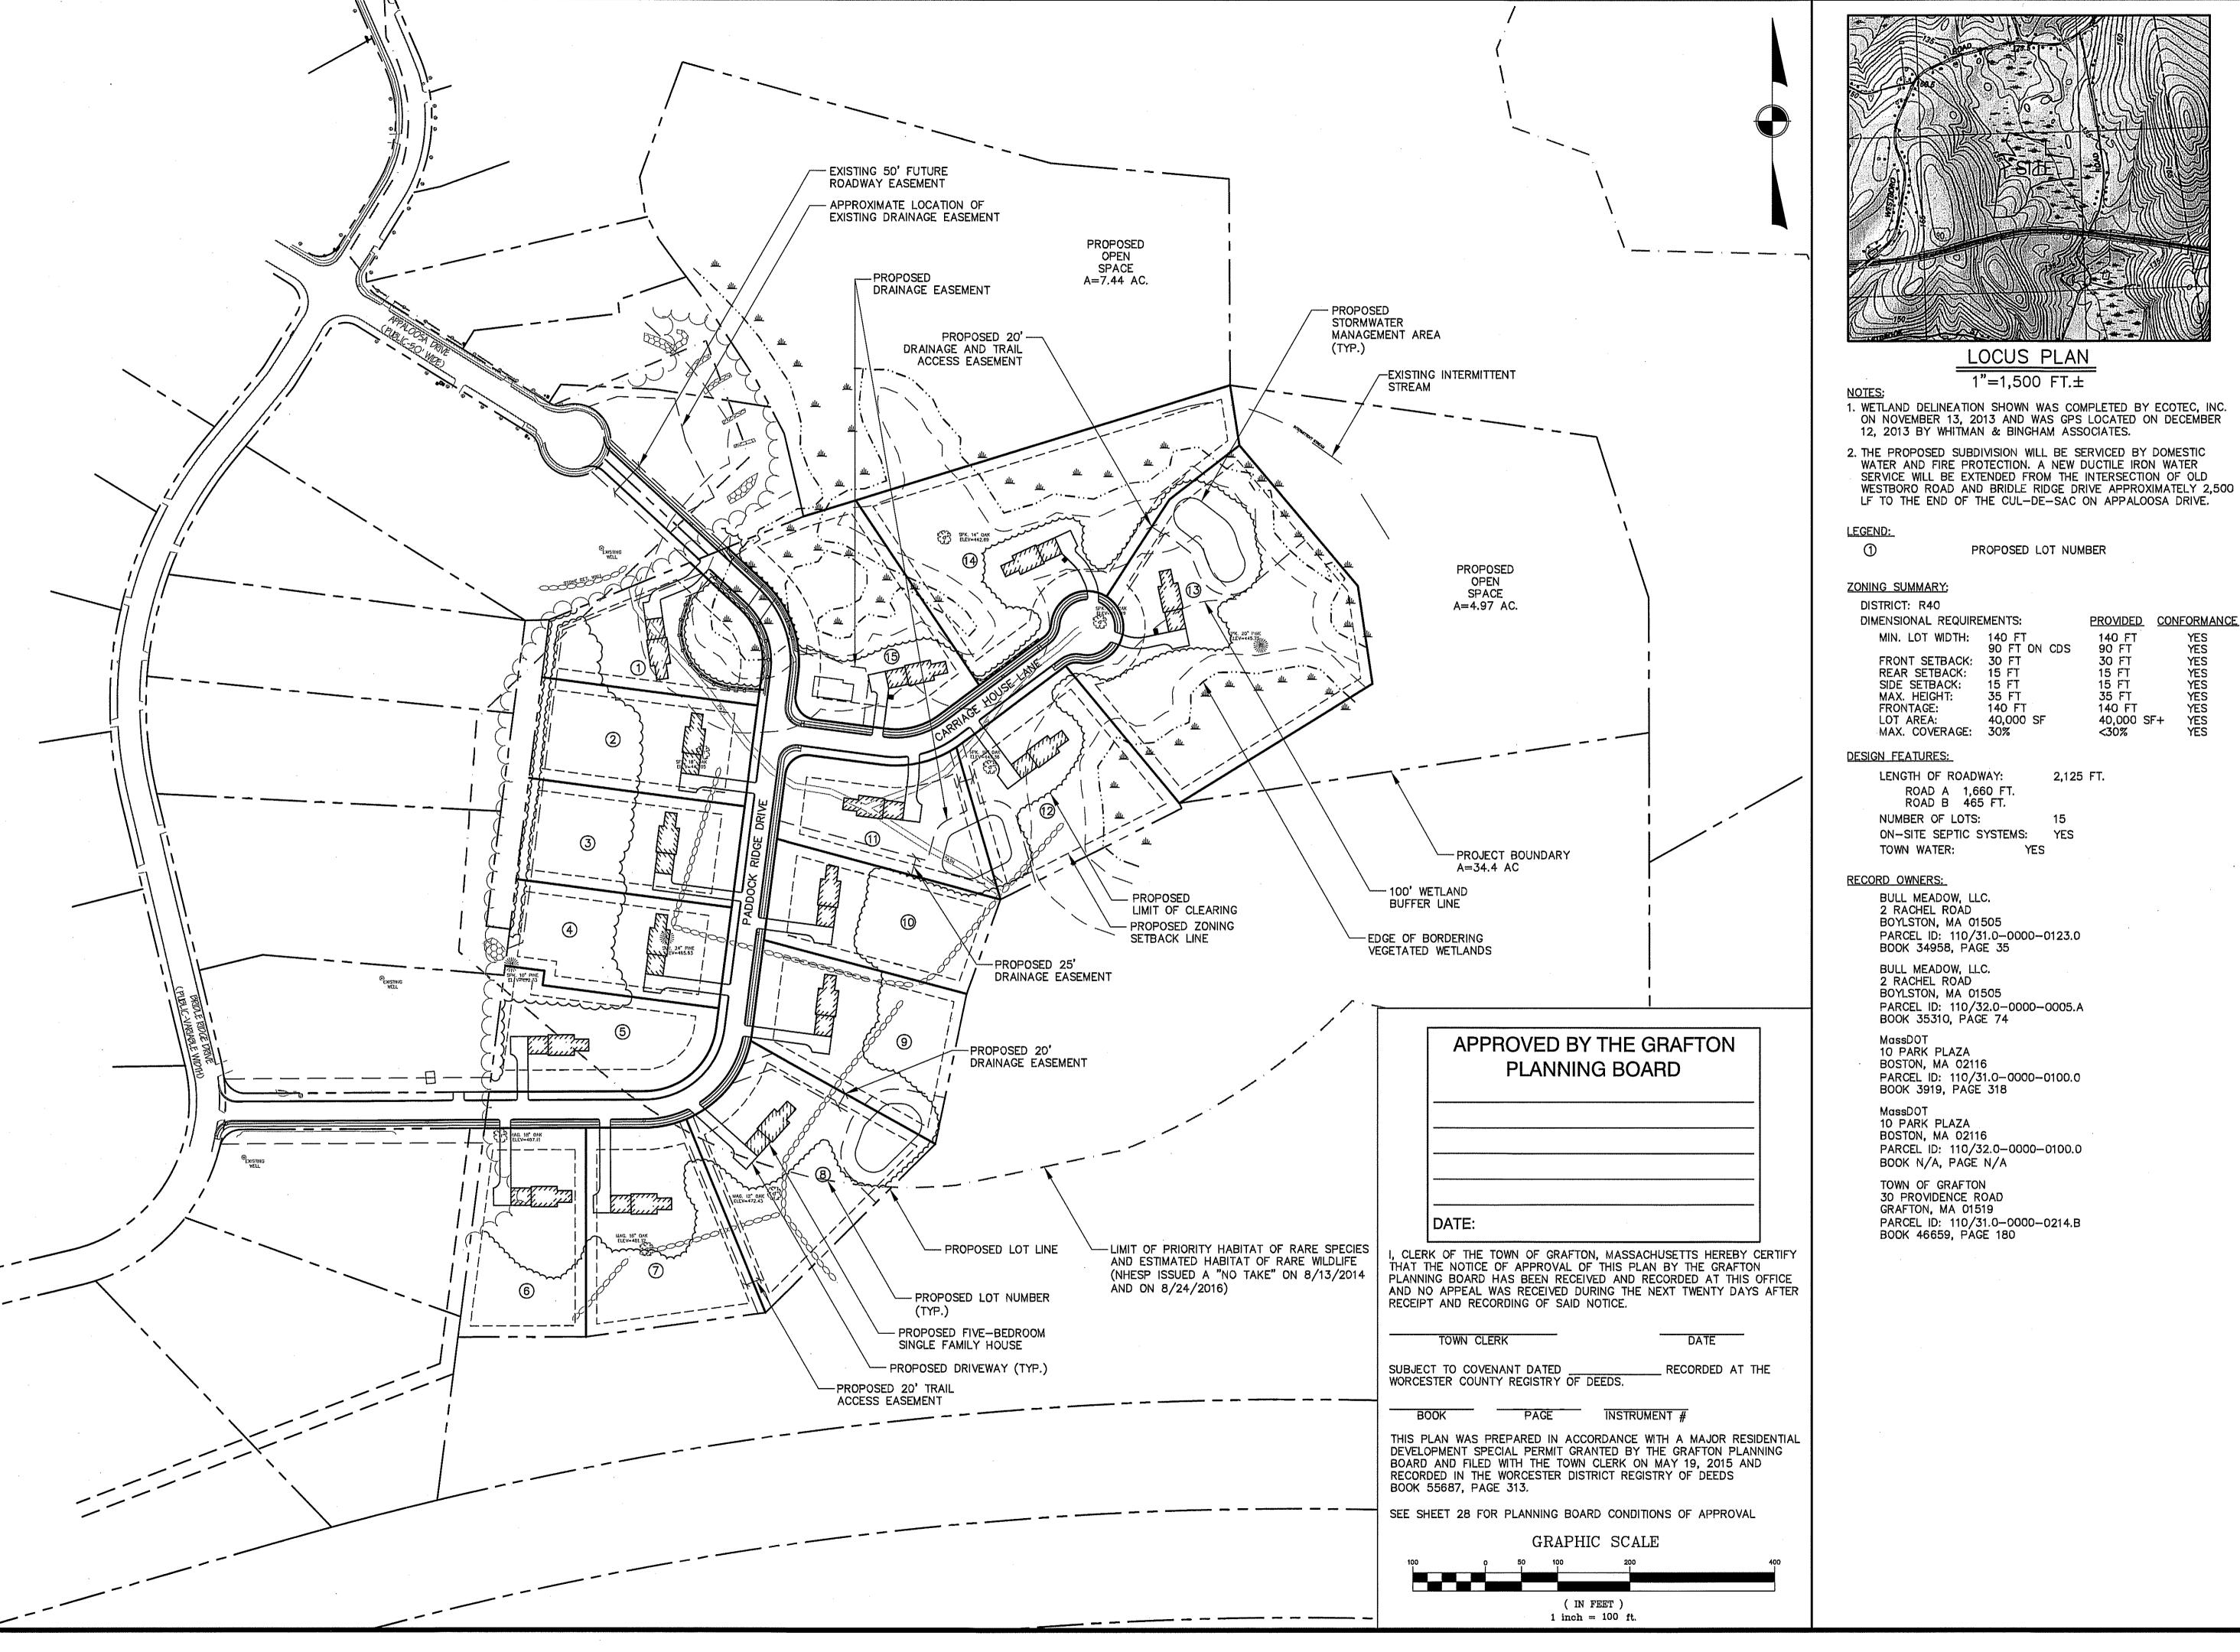

NOT FOR CONSTRUCTION
THESE PLANS WERE PREPARED FOR
THE PURPOSE OF OBTAINING STATE
AND LOCAL PERMITS AND ARE NOT
INTENDED TO BE USED AS
CONSTRUCTION DOCUMENTS.

PREPARED FOR: BULL MEADOW, LLC. 2 RACHEL ROAD BOYLSTON, MA 01505

1 10/11/2016

3 01/09/2017 TOWN COMMENTS
2 11/22/2016 TOWN COMMENTS

TOWN COMMENTS

Revision

No. Date

BRIAN R. MARCHETTI CIVIL NO. 46279

Drawn By: Designed By: Checked By:

BRM BRM 73104

## McCarty Engineering, Inc. Civil Engineers

42 Jungle Road, Leominster, MA 01453 phone:(978) 534-1318 fax: (978) 840-6907 www.mccartydb.com

Project Name

Estates at Bull Meadow
Definitive Plan
N. Grafton, MA 01536


Overall Conventional


Subdivision Plan
(1 of 3)


 Job No: 066
 Sheet No.


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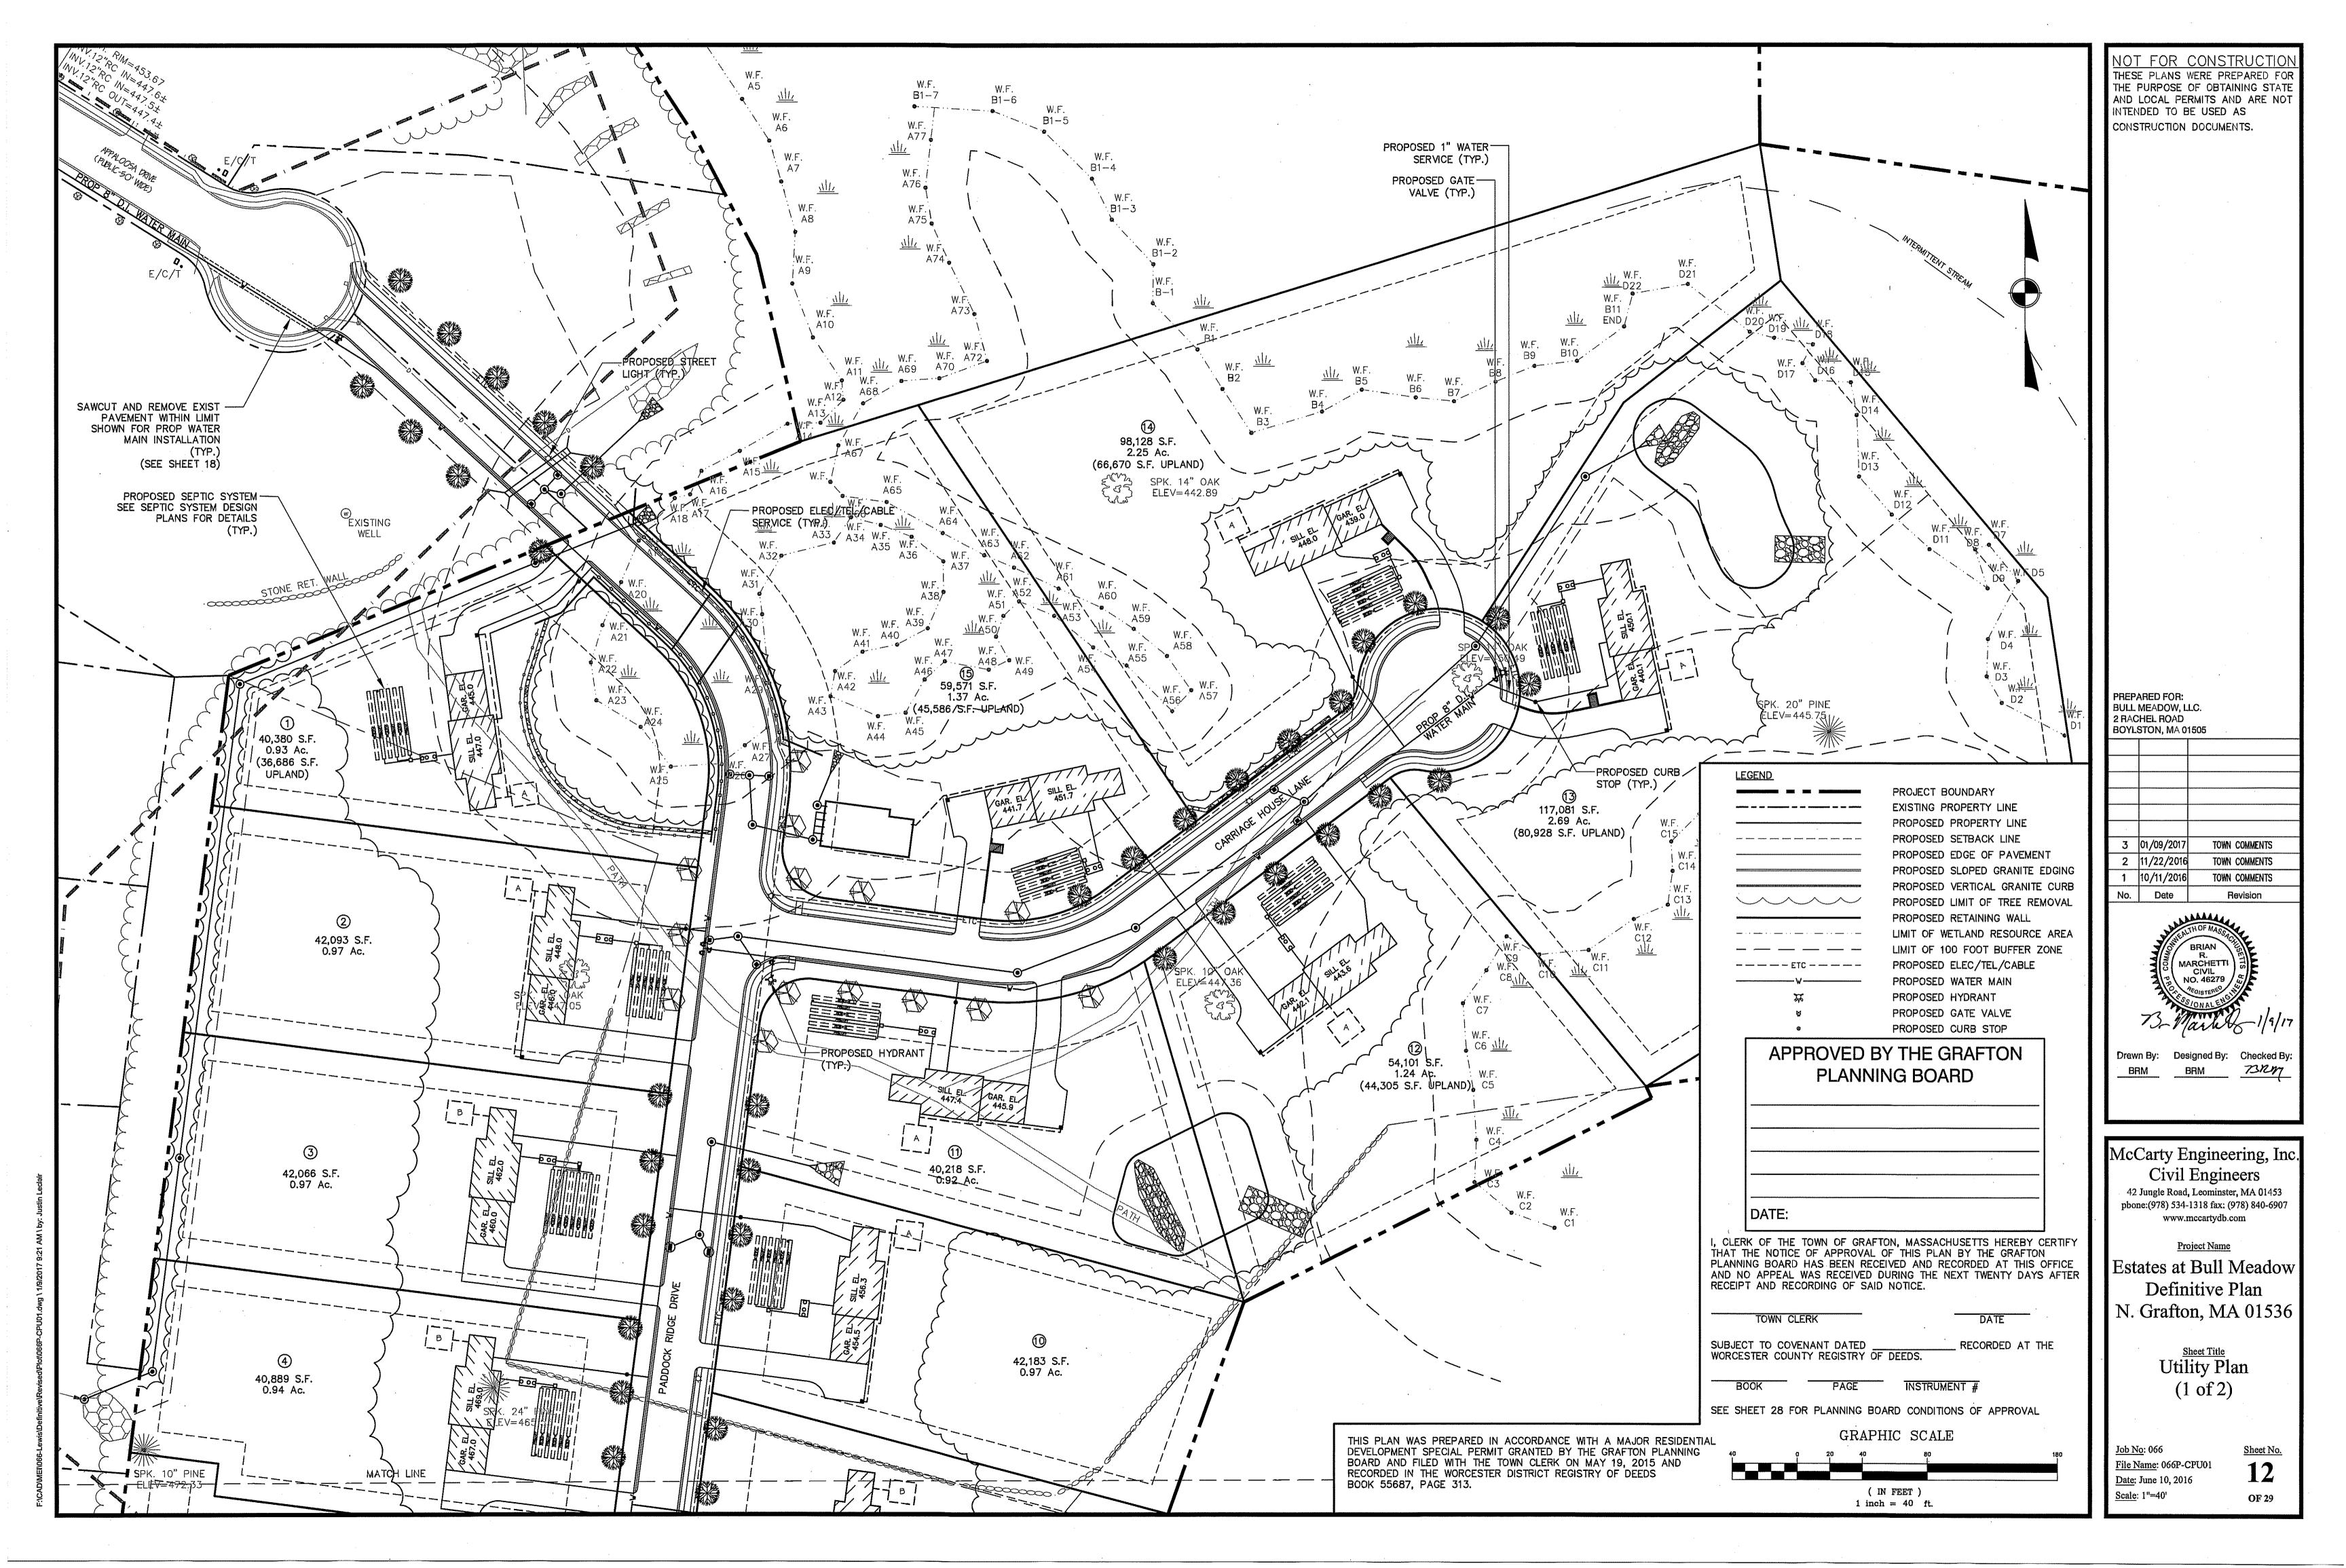
 Date: June 10, 2016
 OF 29




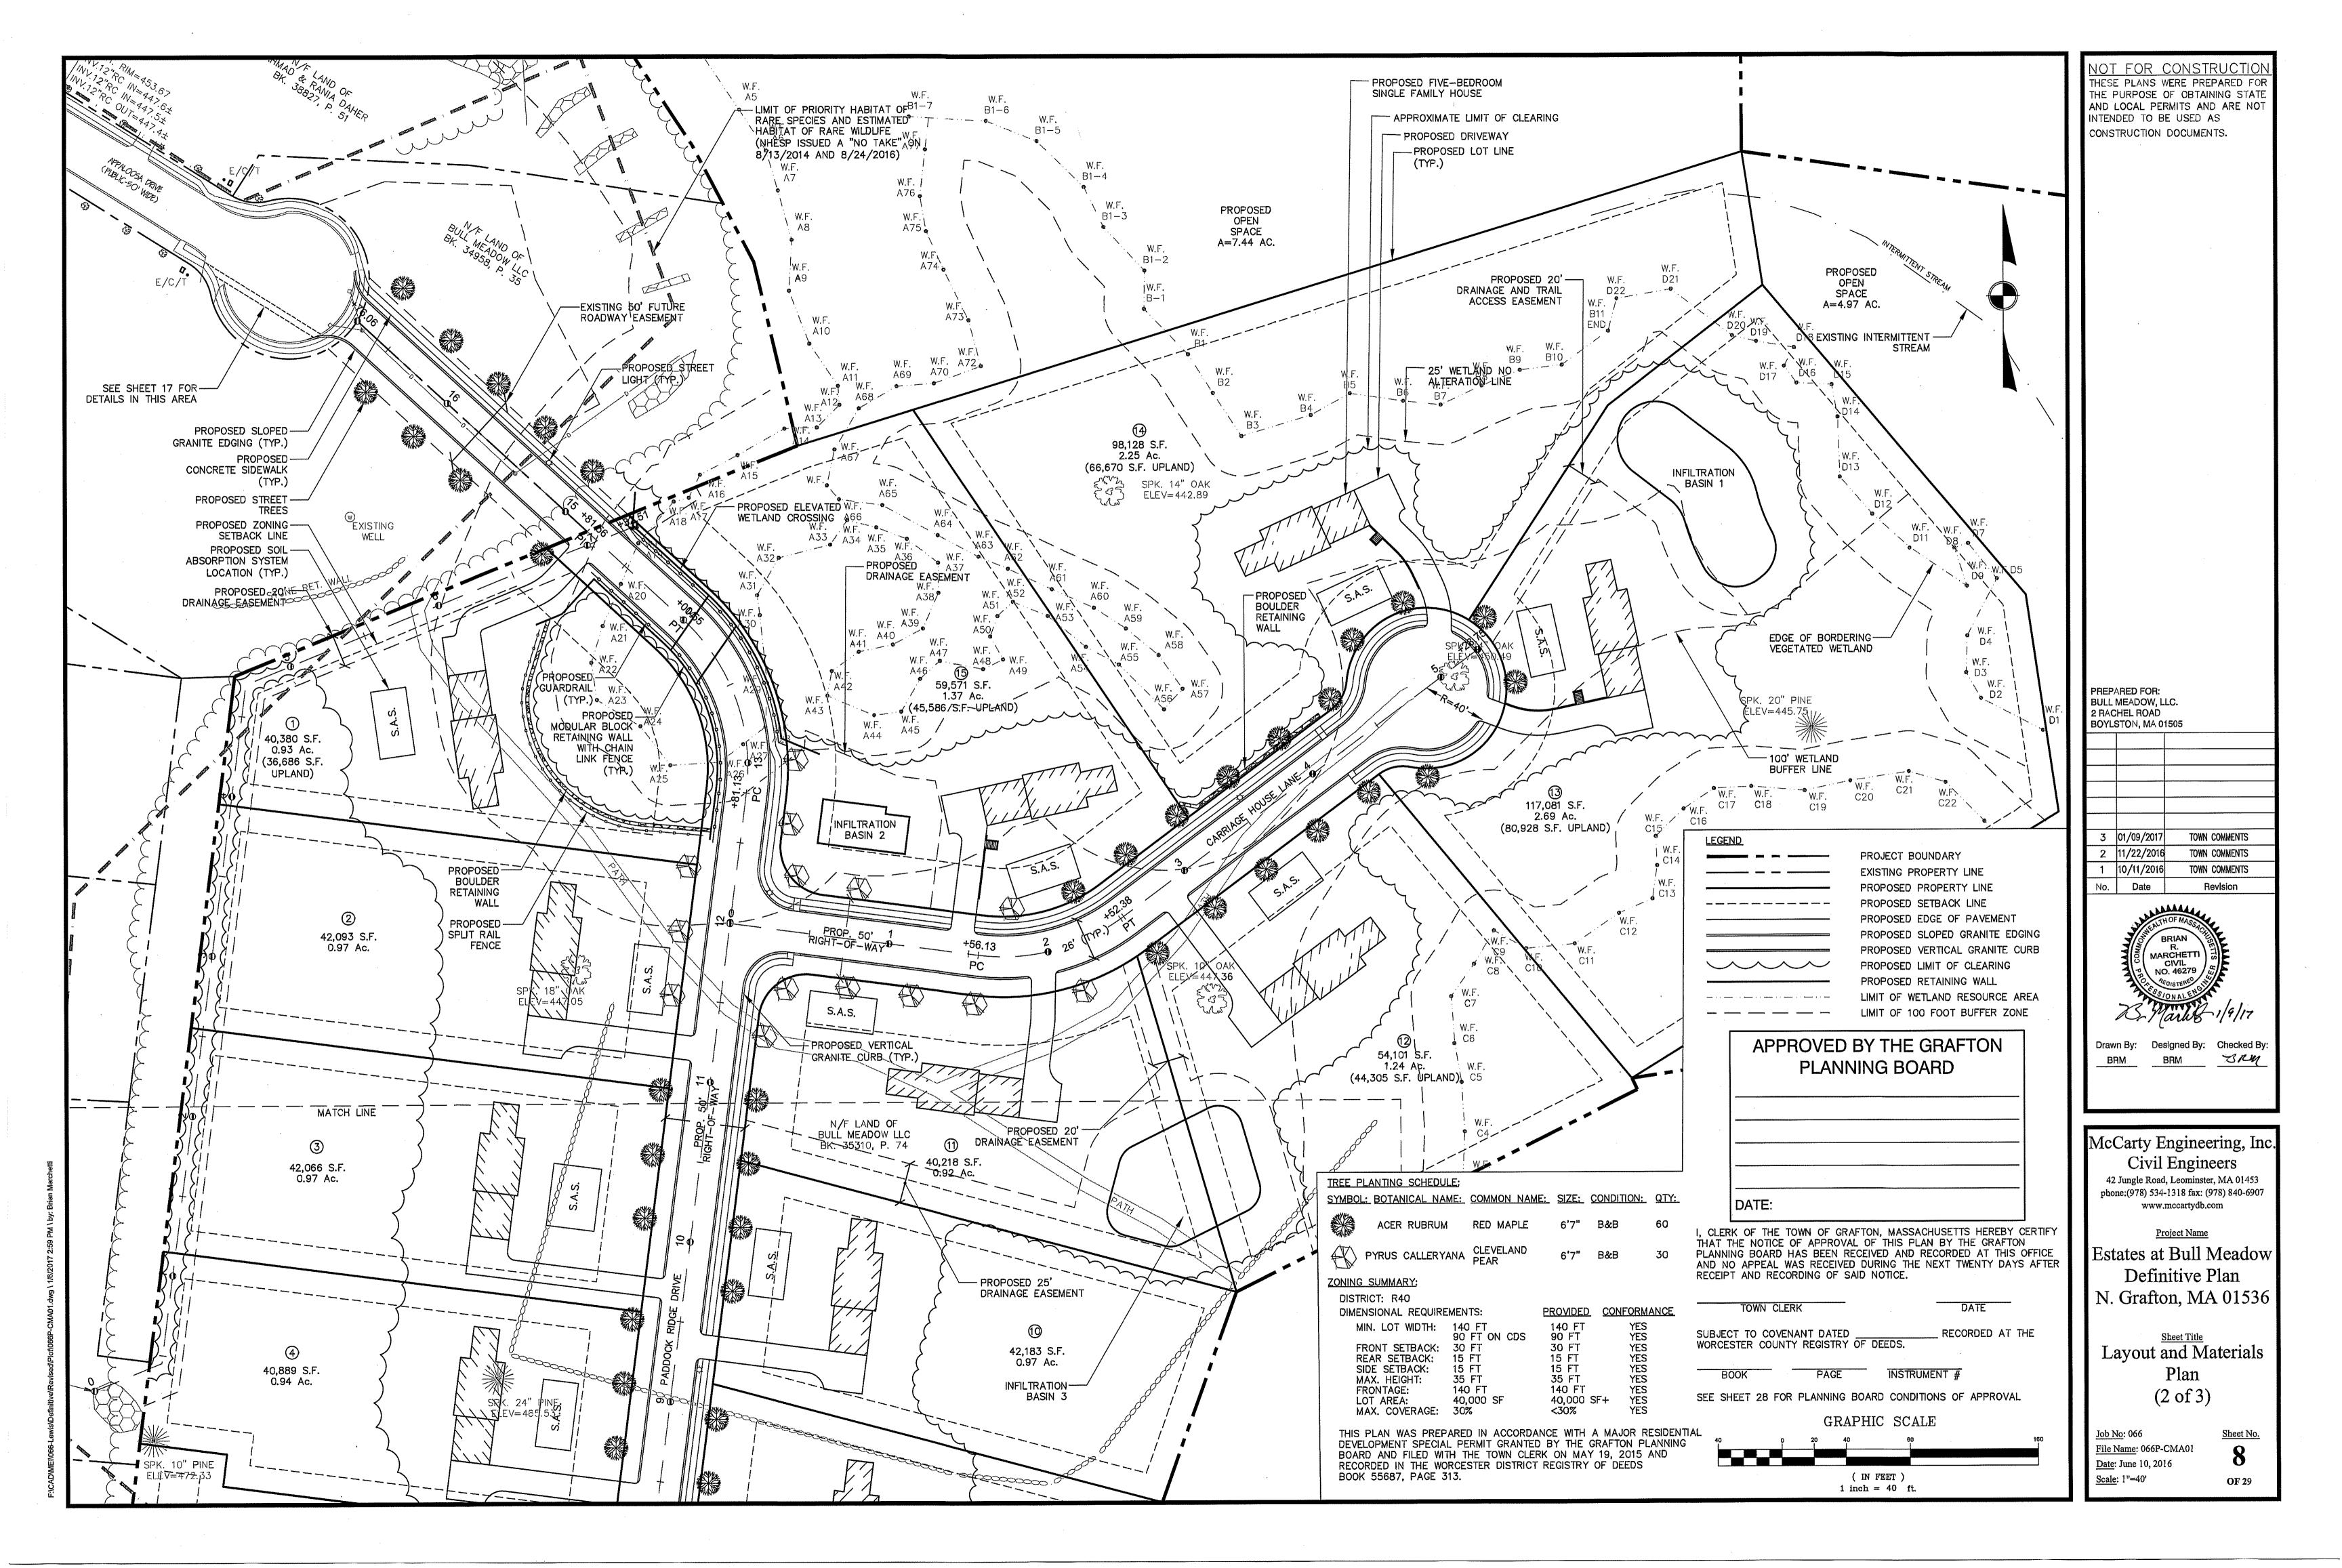


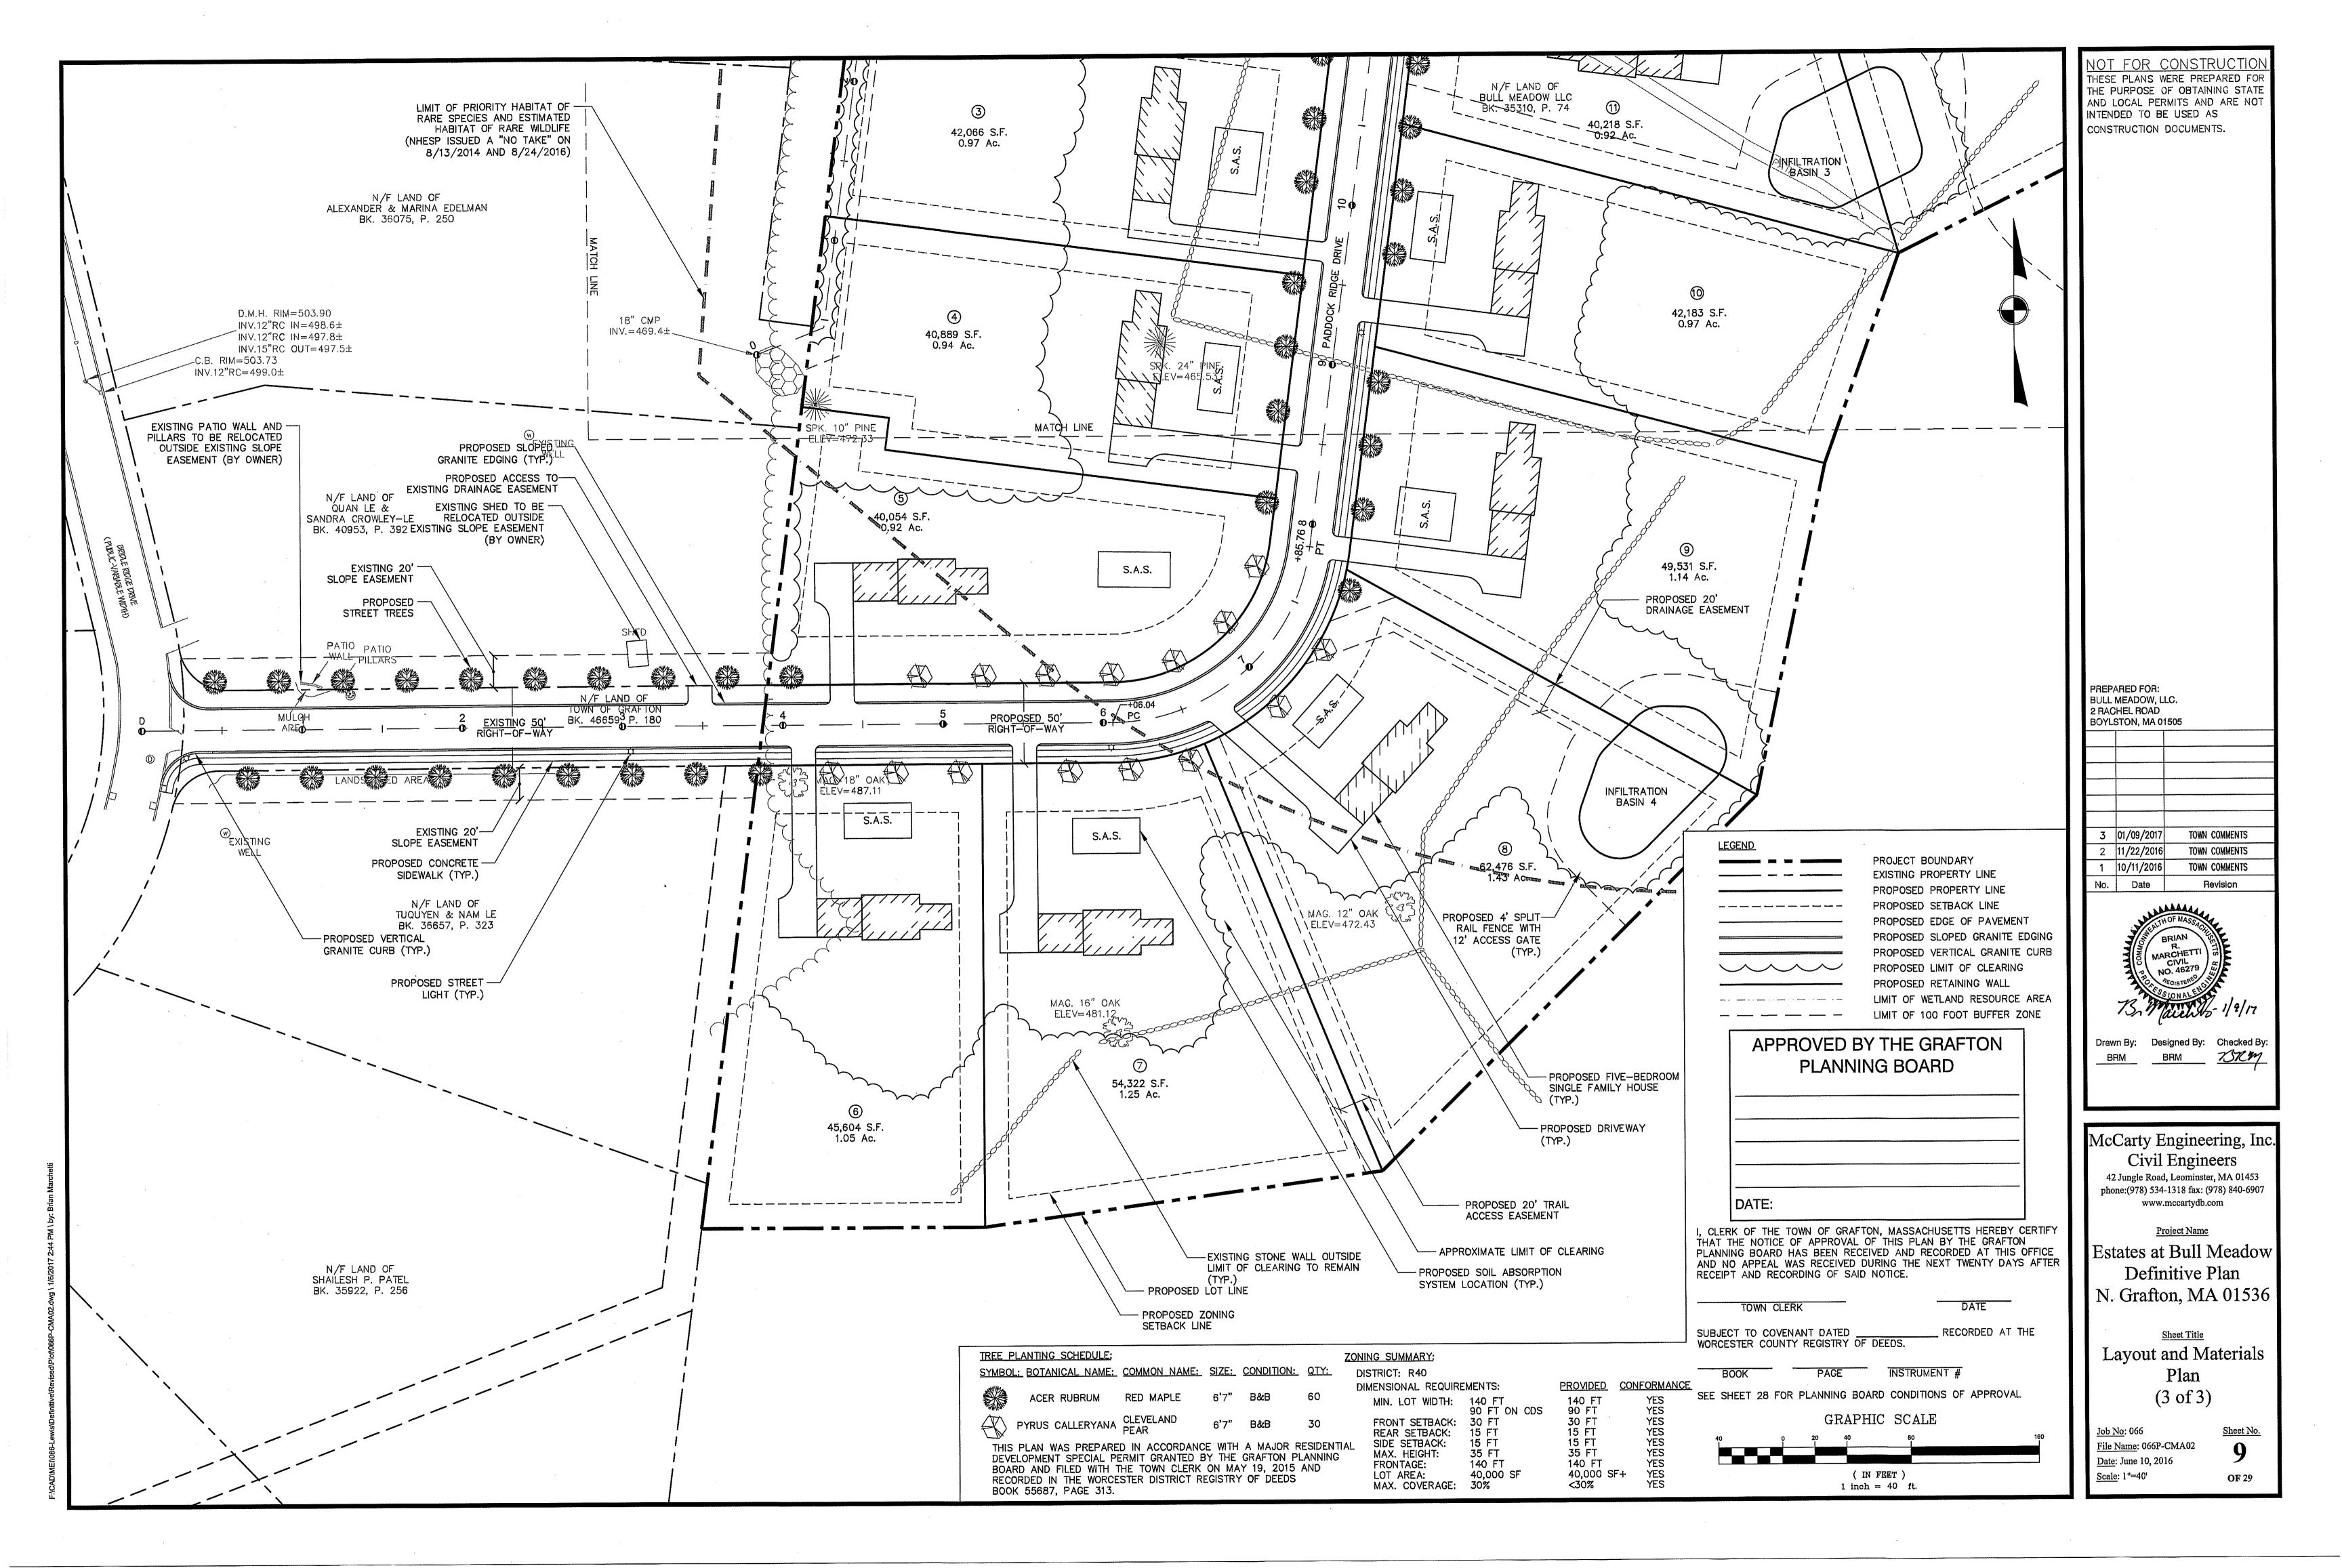


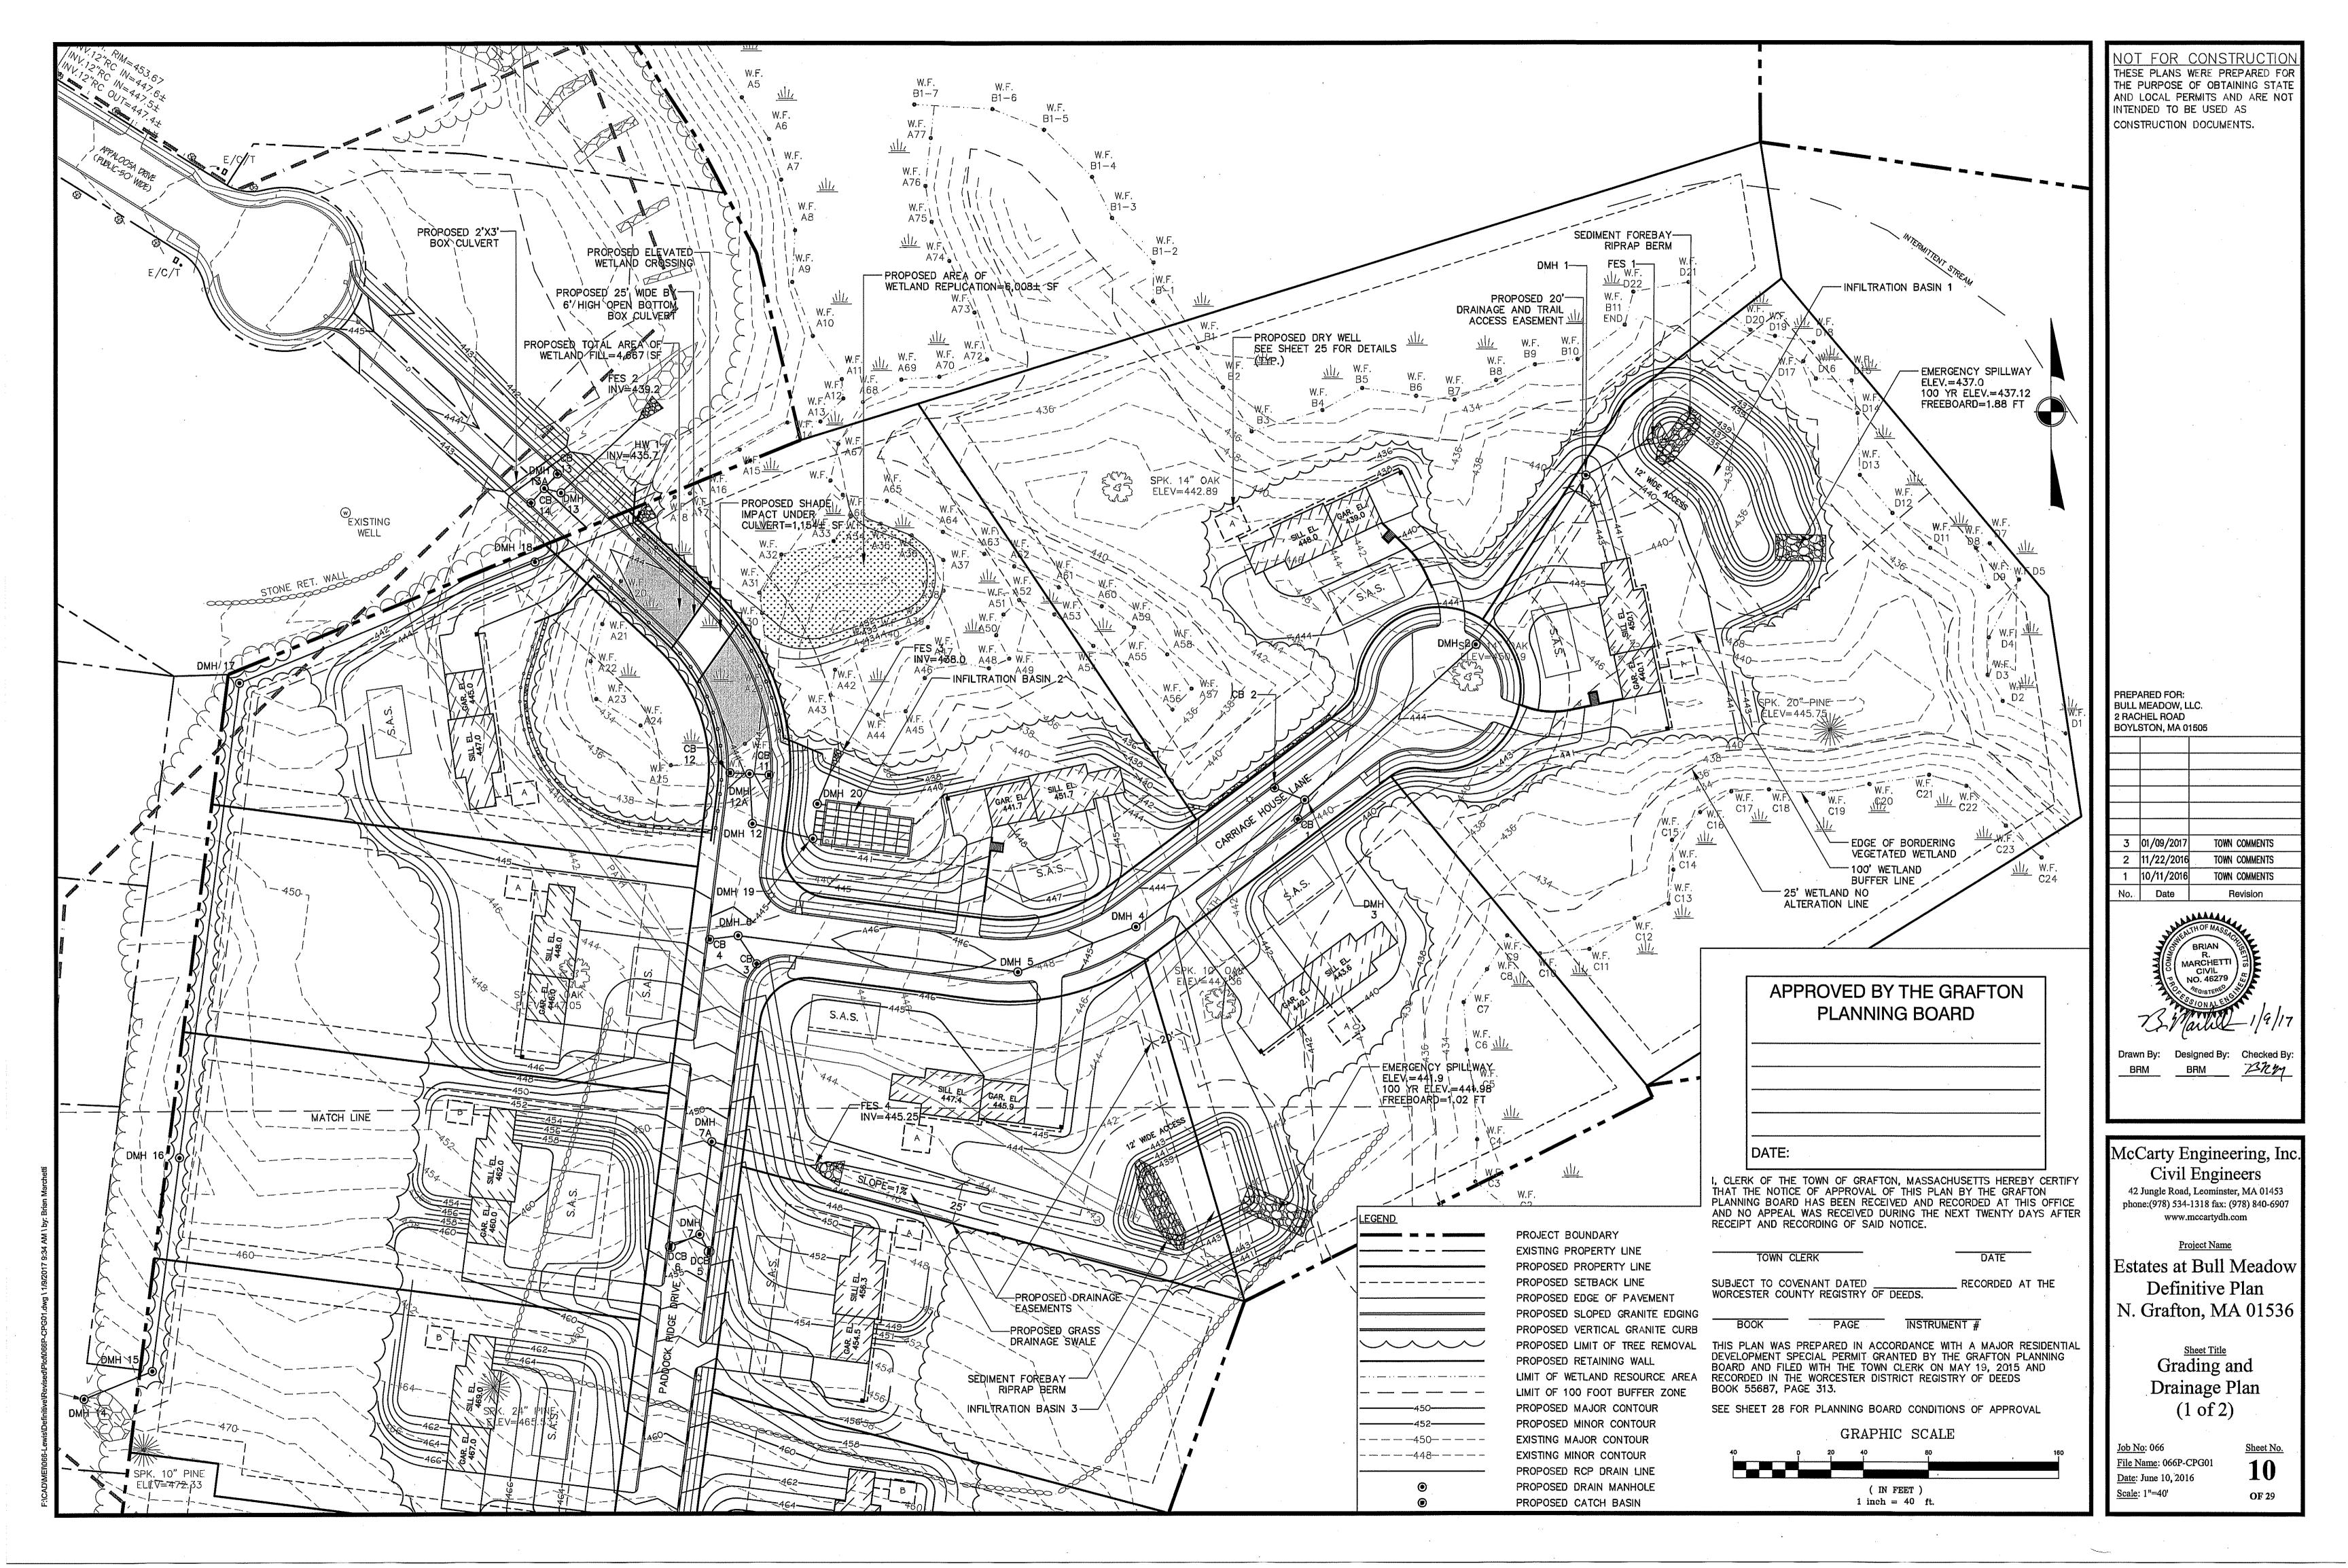

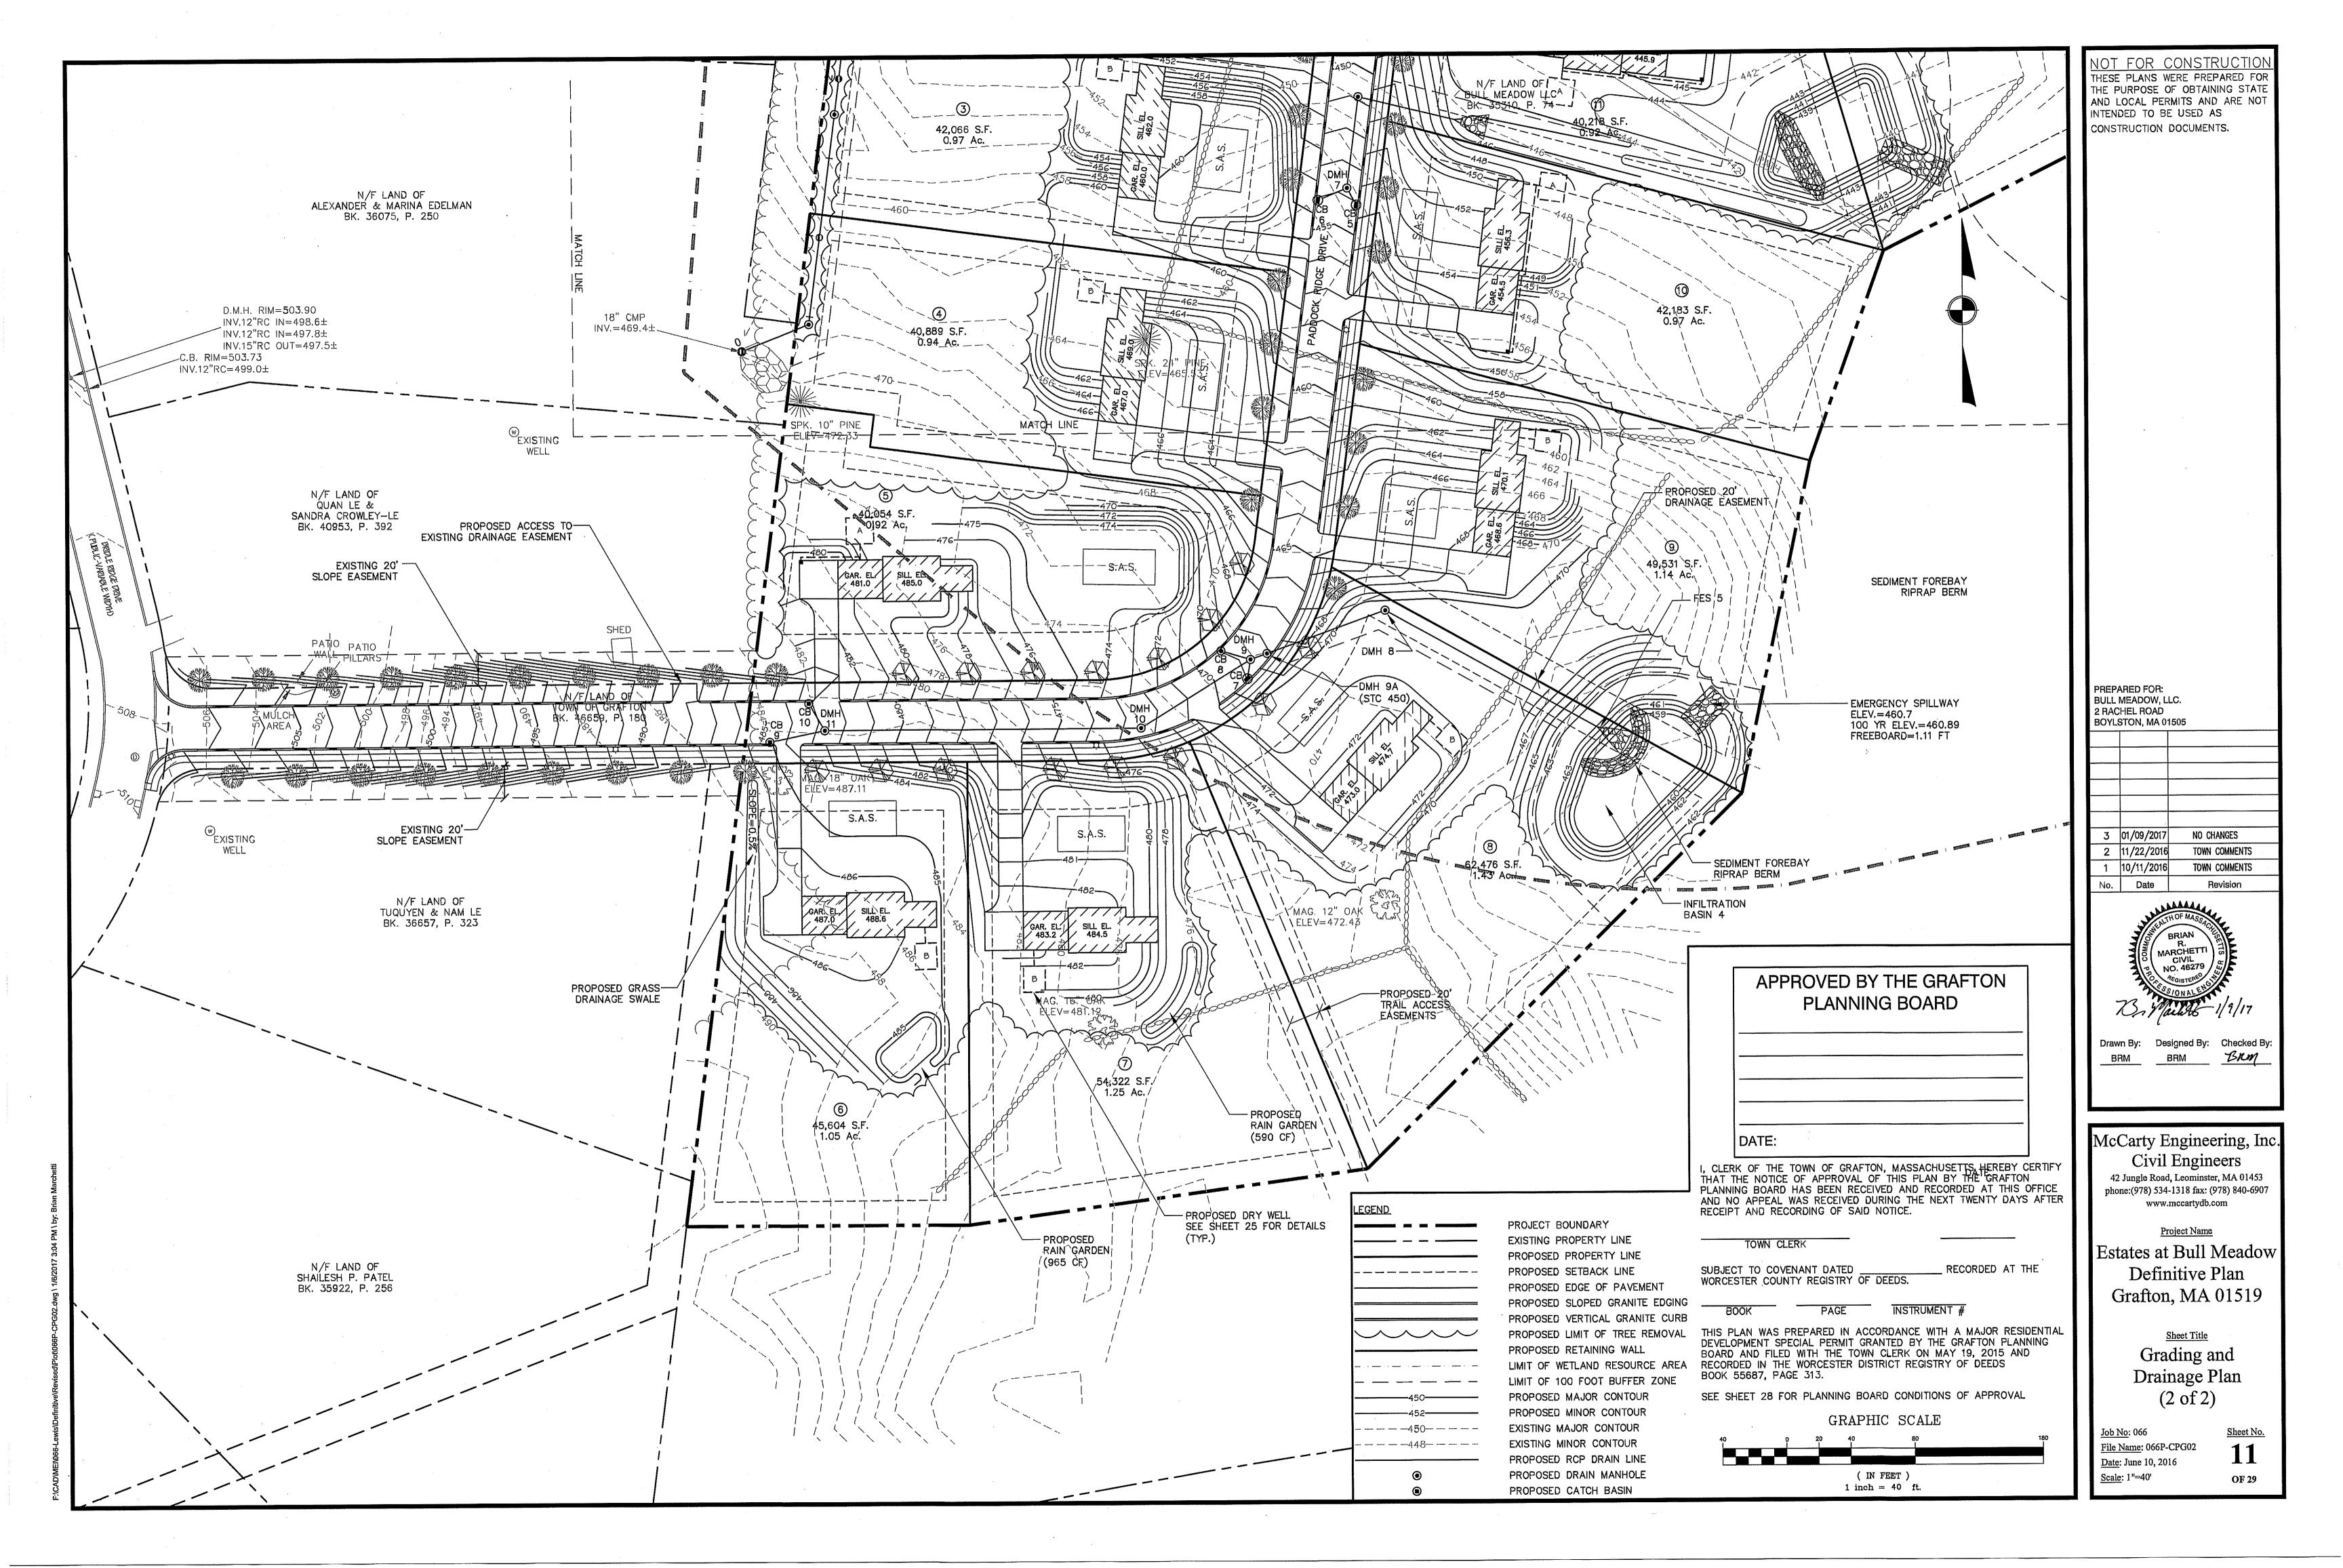

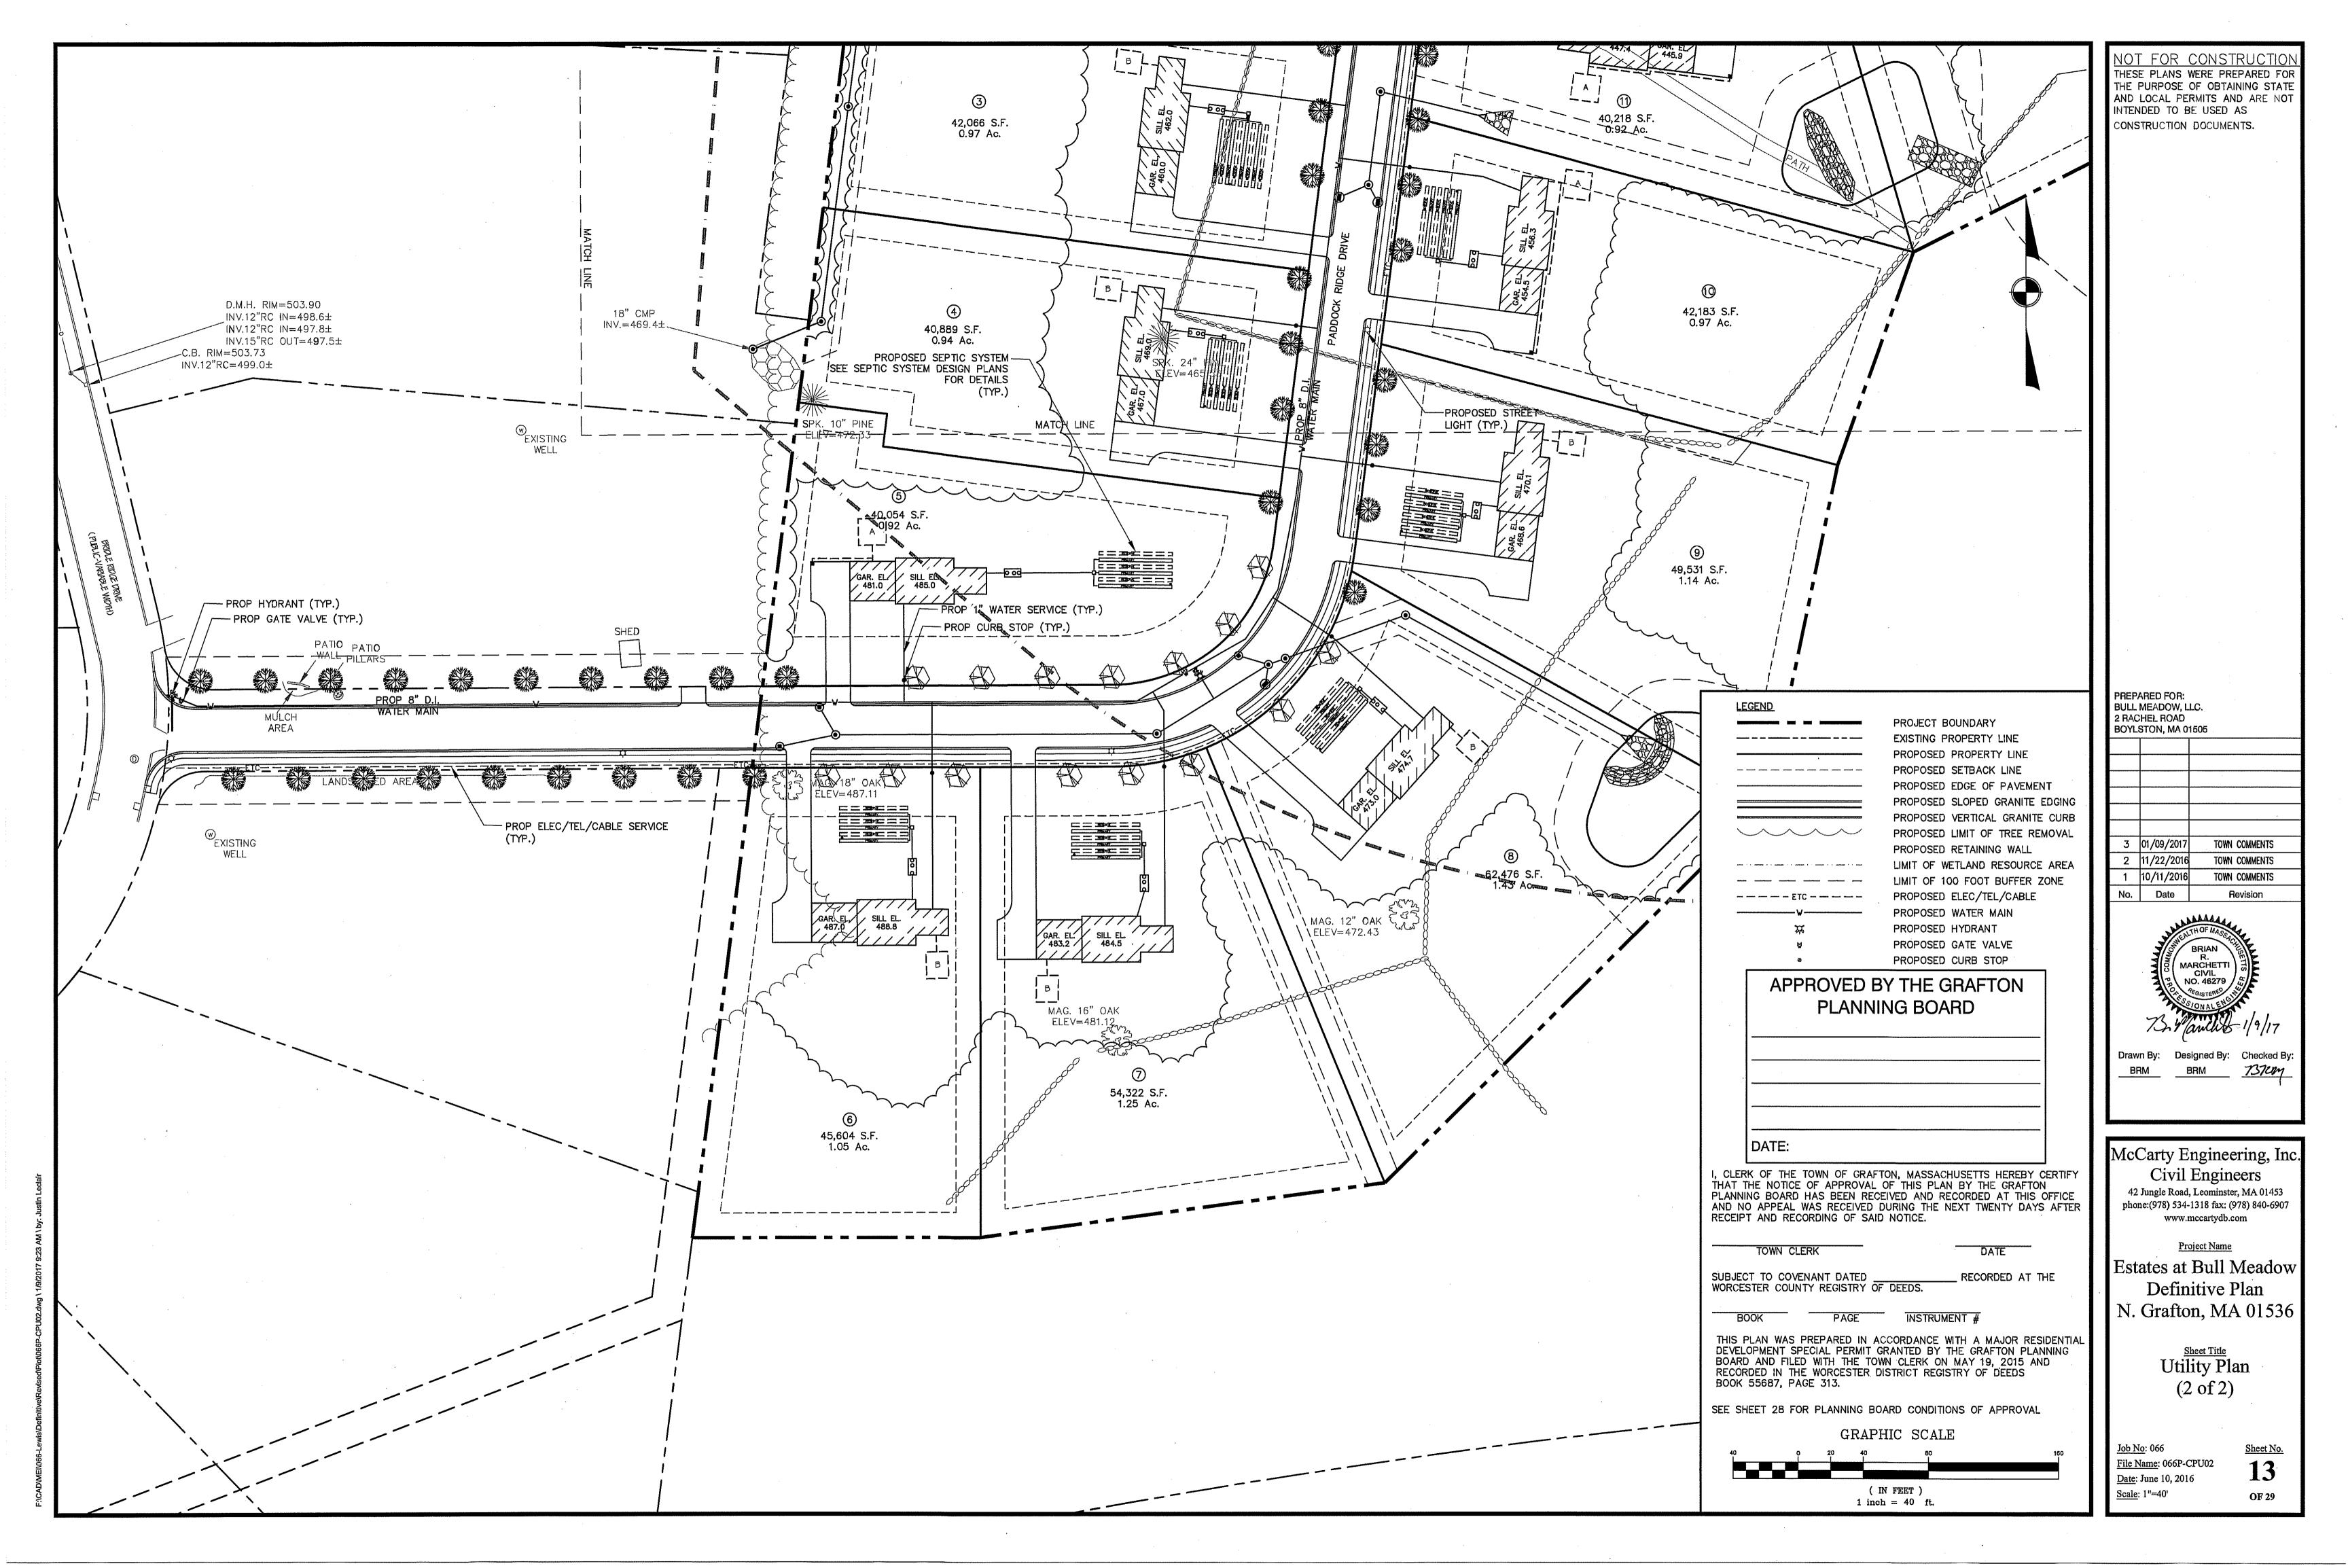

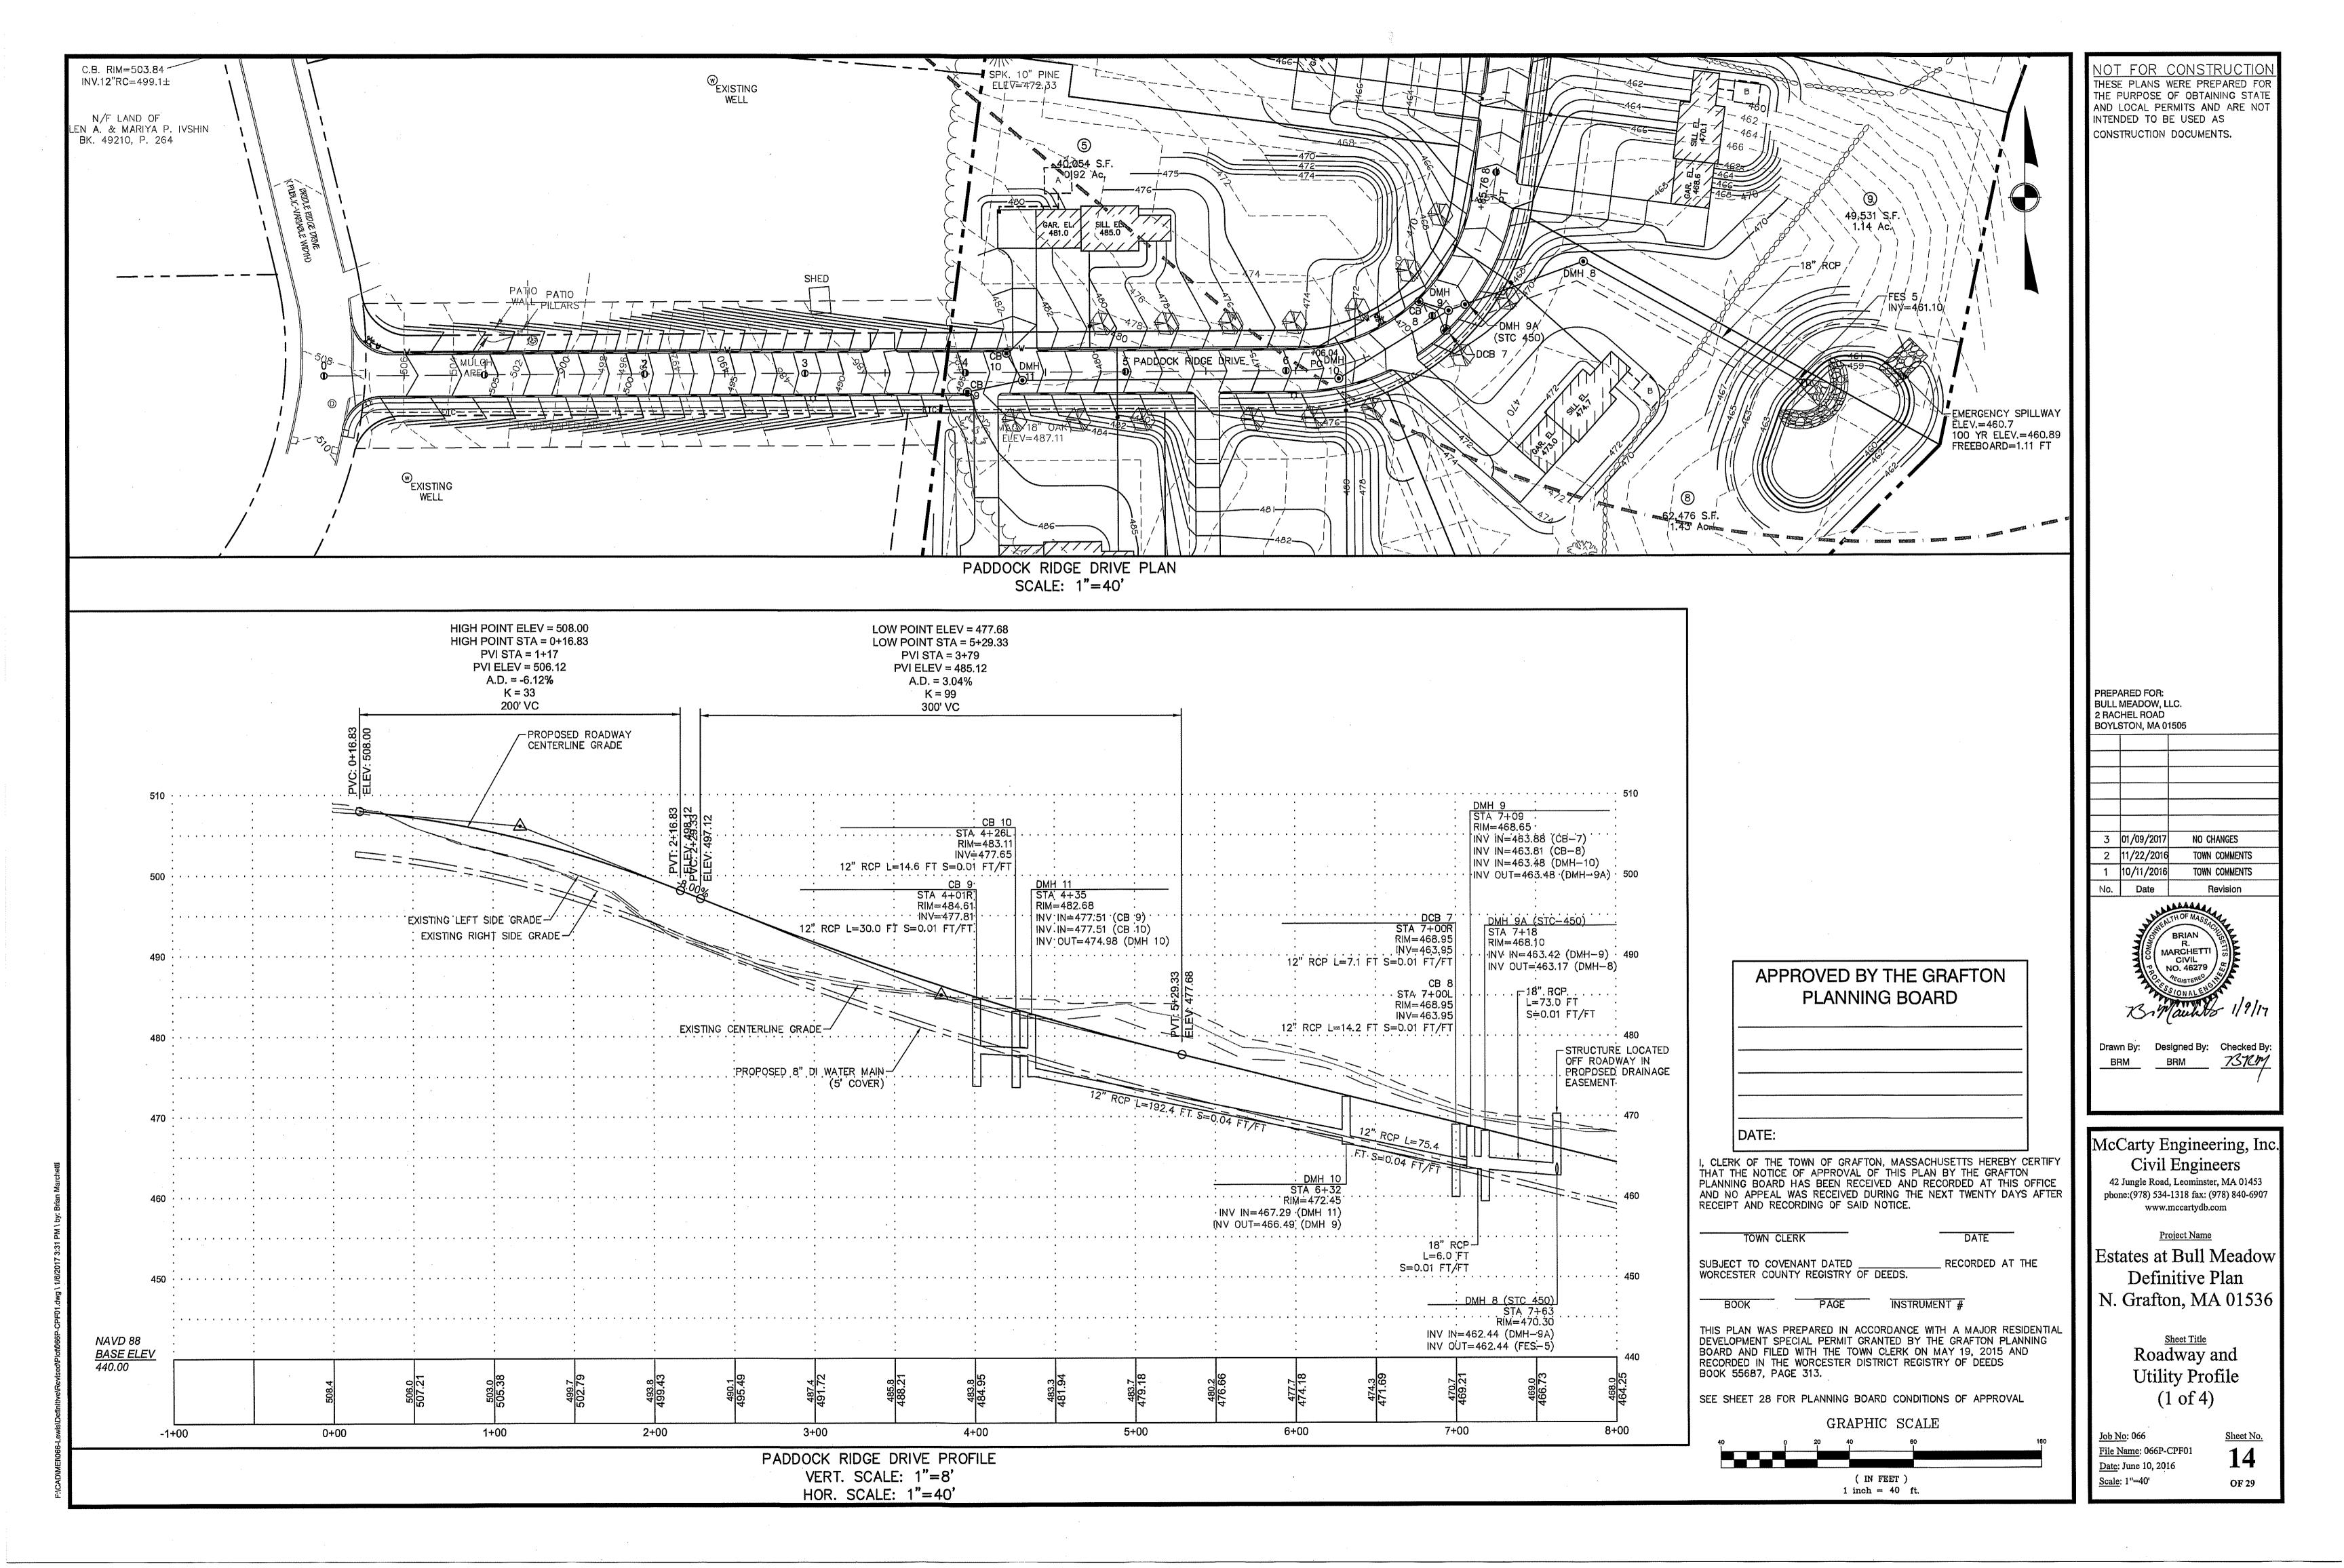

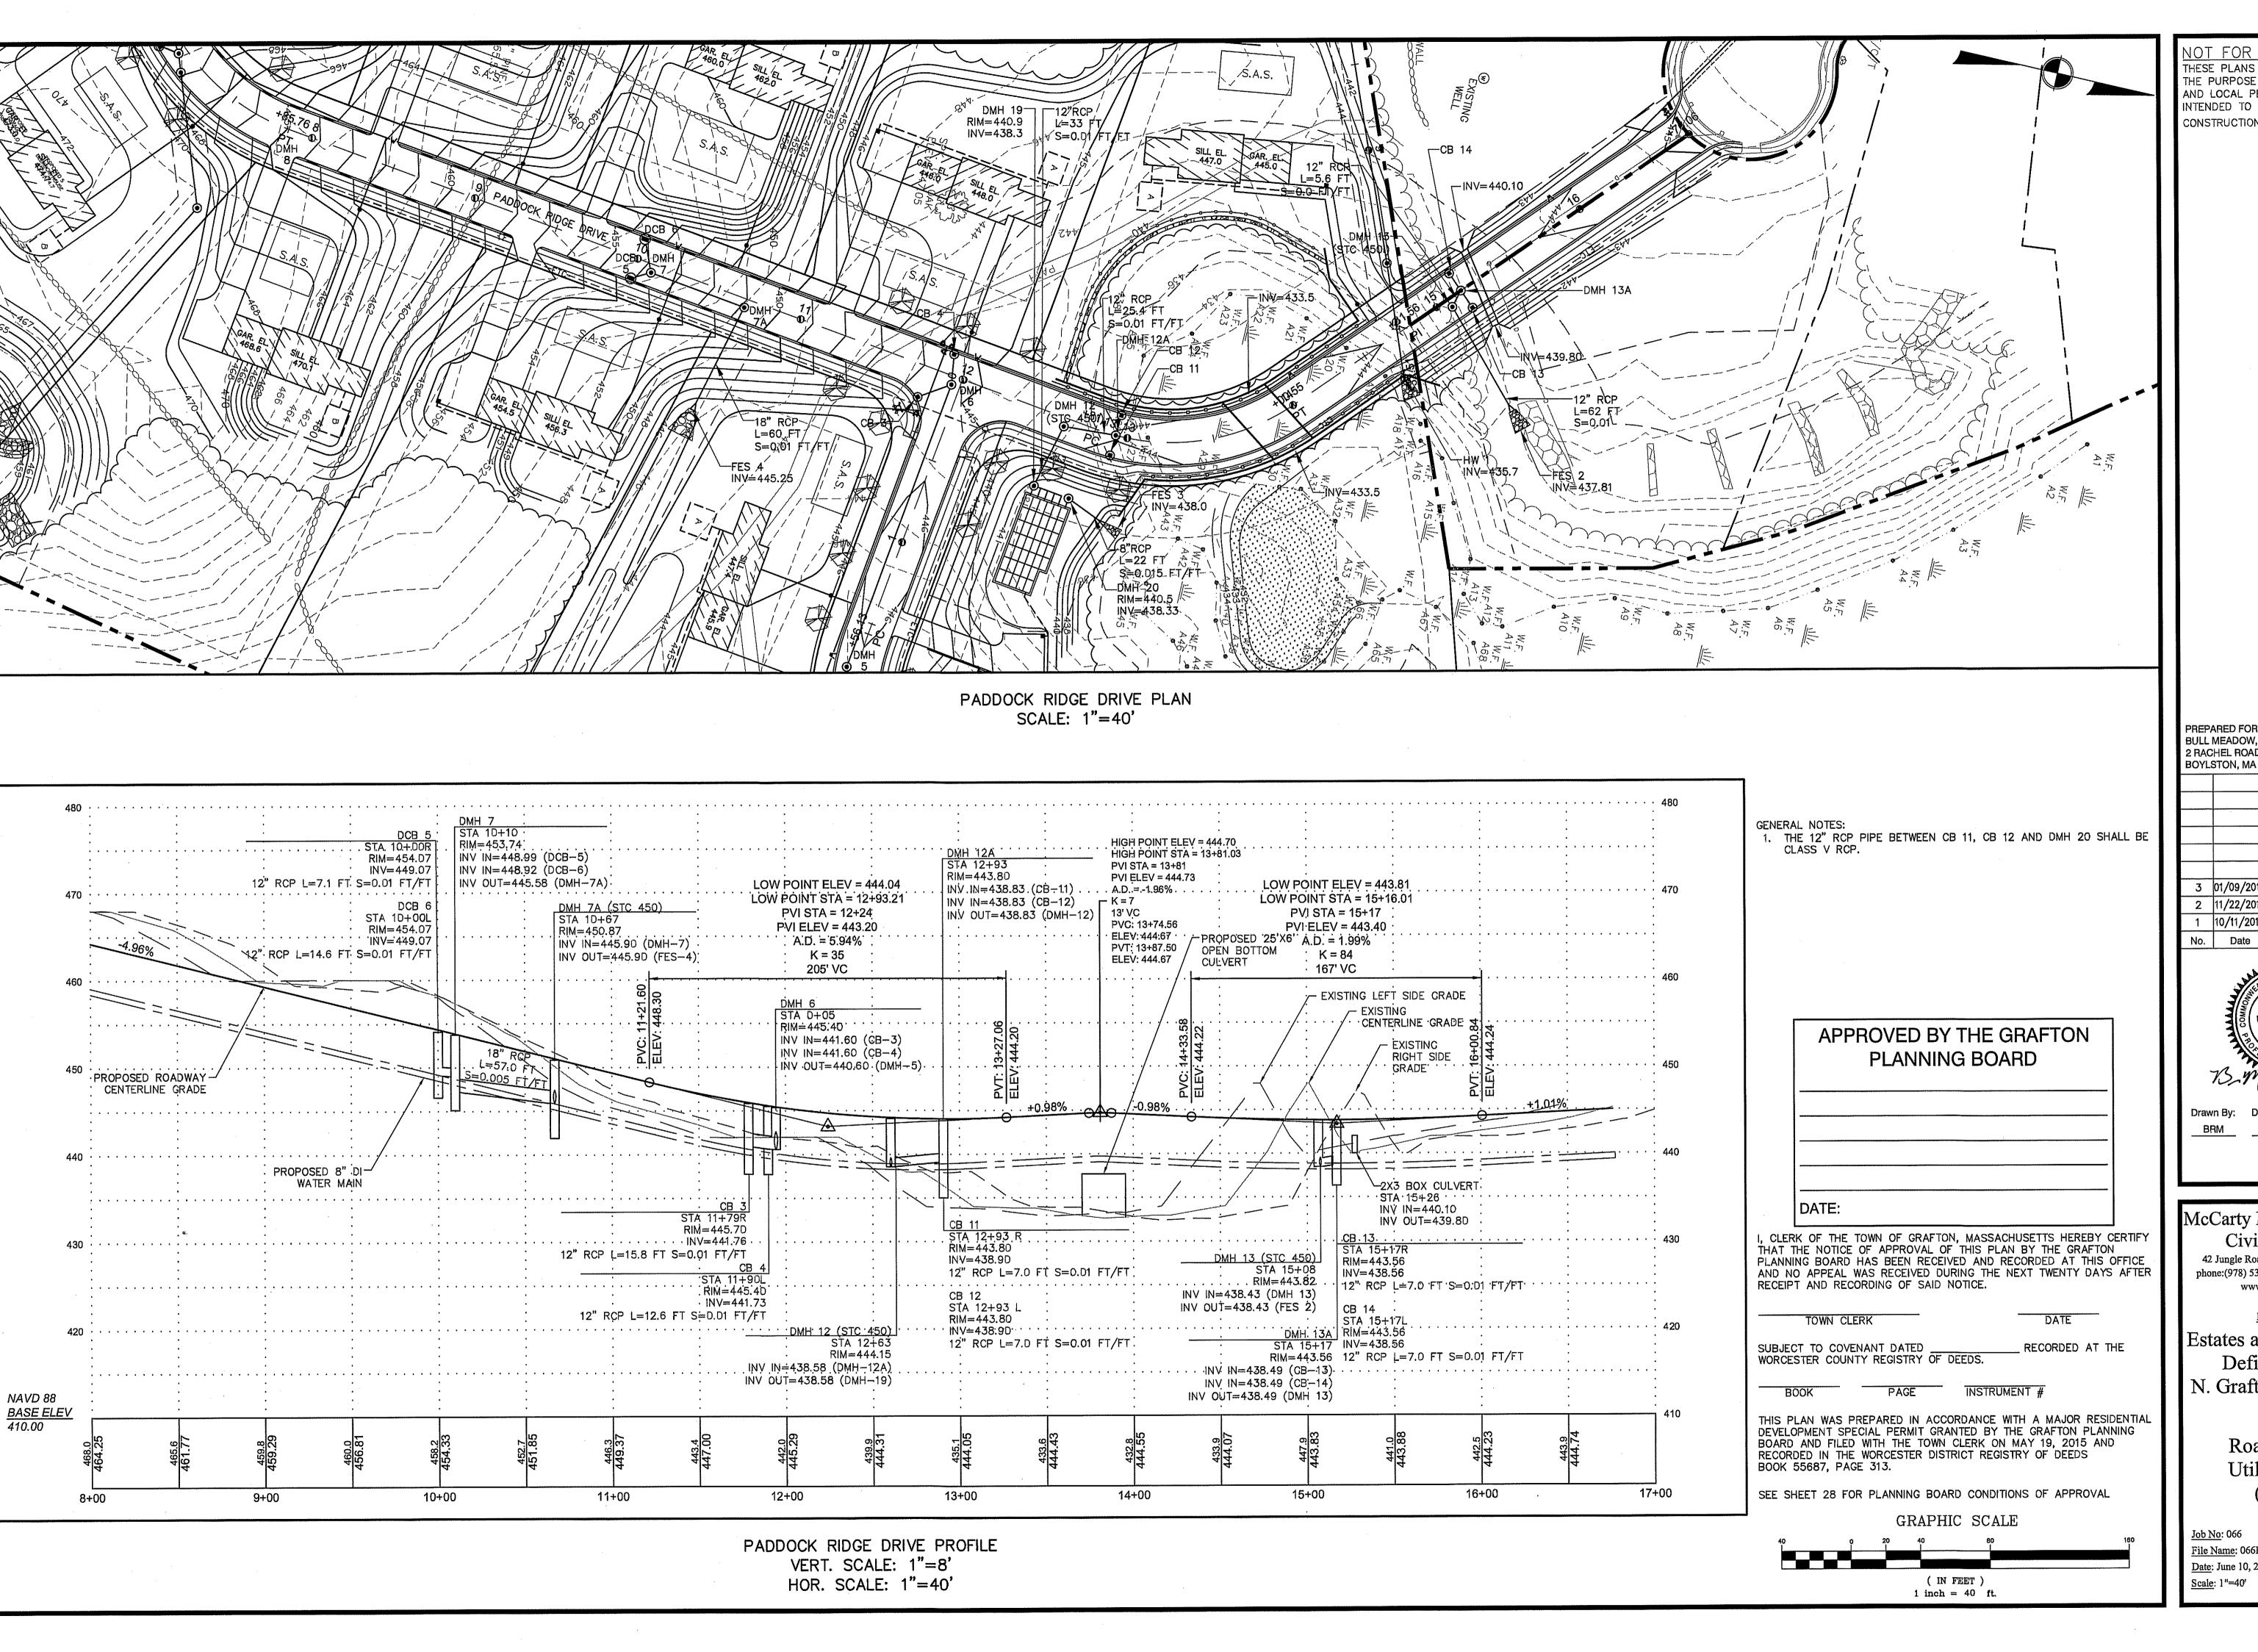

INTENDED TO BE USED AS CONSTRUCTION DOCUMENTS.

PREPARED FOR: BULL MEADOW, LLC. 2 RACHEL ROAD BOYLSTON, MA 01505

3 01/09/2017 TOWN COMMENTS 2 11/22/2016 TOWN COMMENTS 1 10/11/2016 TOWN COMMENTS Revision



Designed By: Checked By:

McCarty Engineering, Inc. Civil Engineers 42 Jungle Road, Leominster, MA 01453 phone:(978) 534-1318 fax: (978) 840-6907


Project Name


www.mccartydb.com

Estates at Bull Meadow Definitive Plan N. Grafton, MA 01536

> Shect Title Roadway and **Utility Profile** (2 of 4)

File Name: 066P-CPF02 Date: June 10, 2016

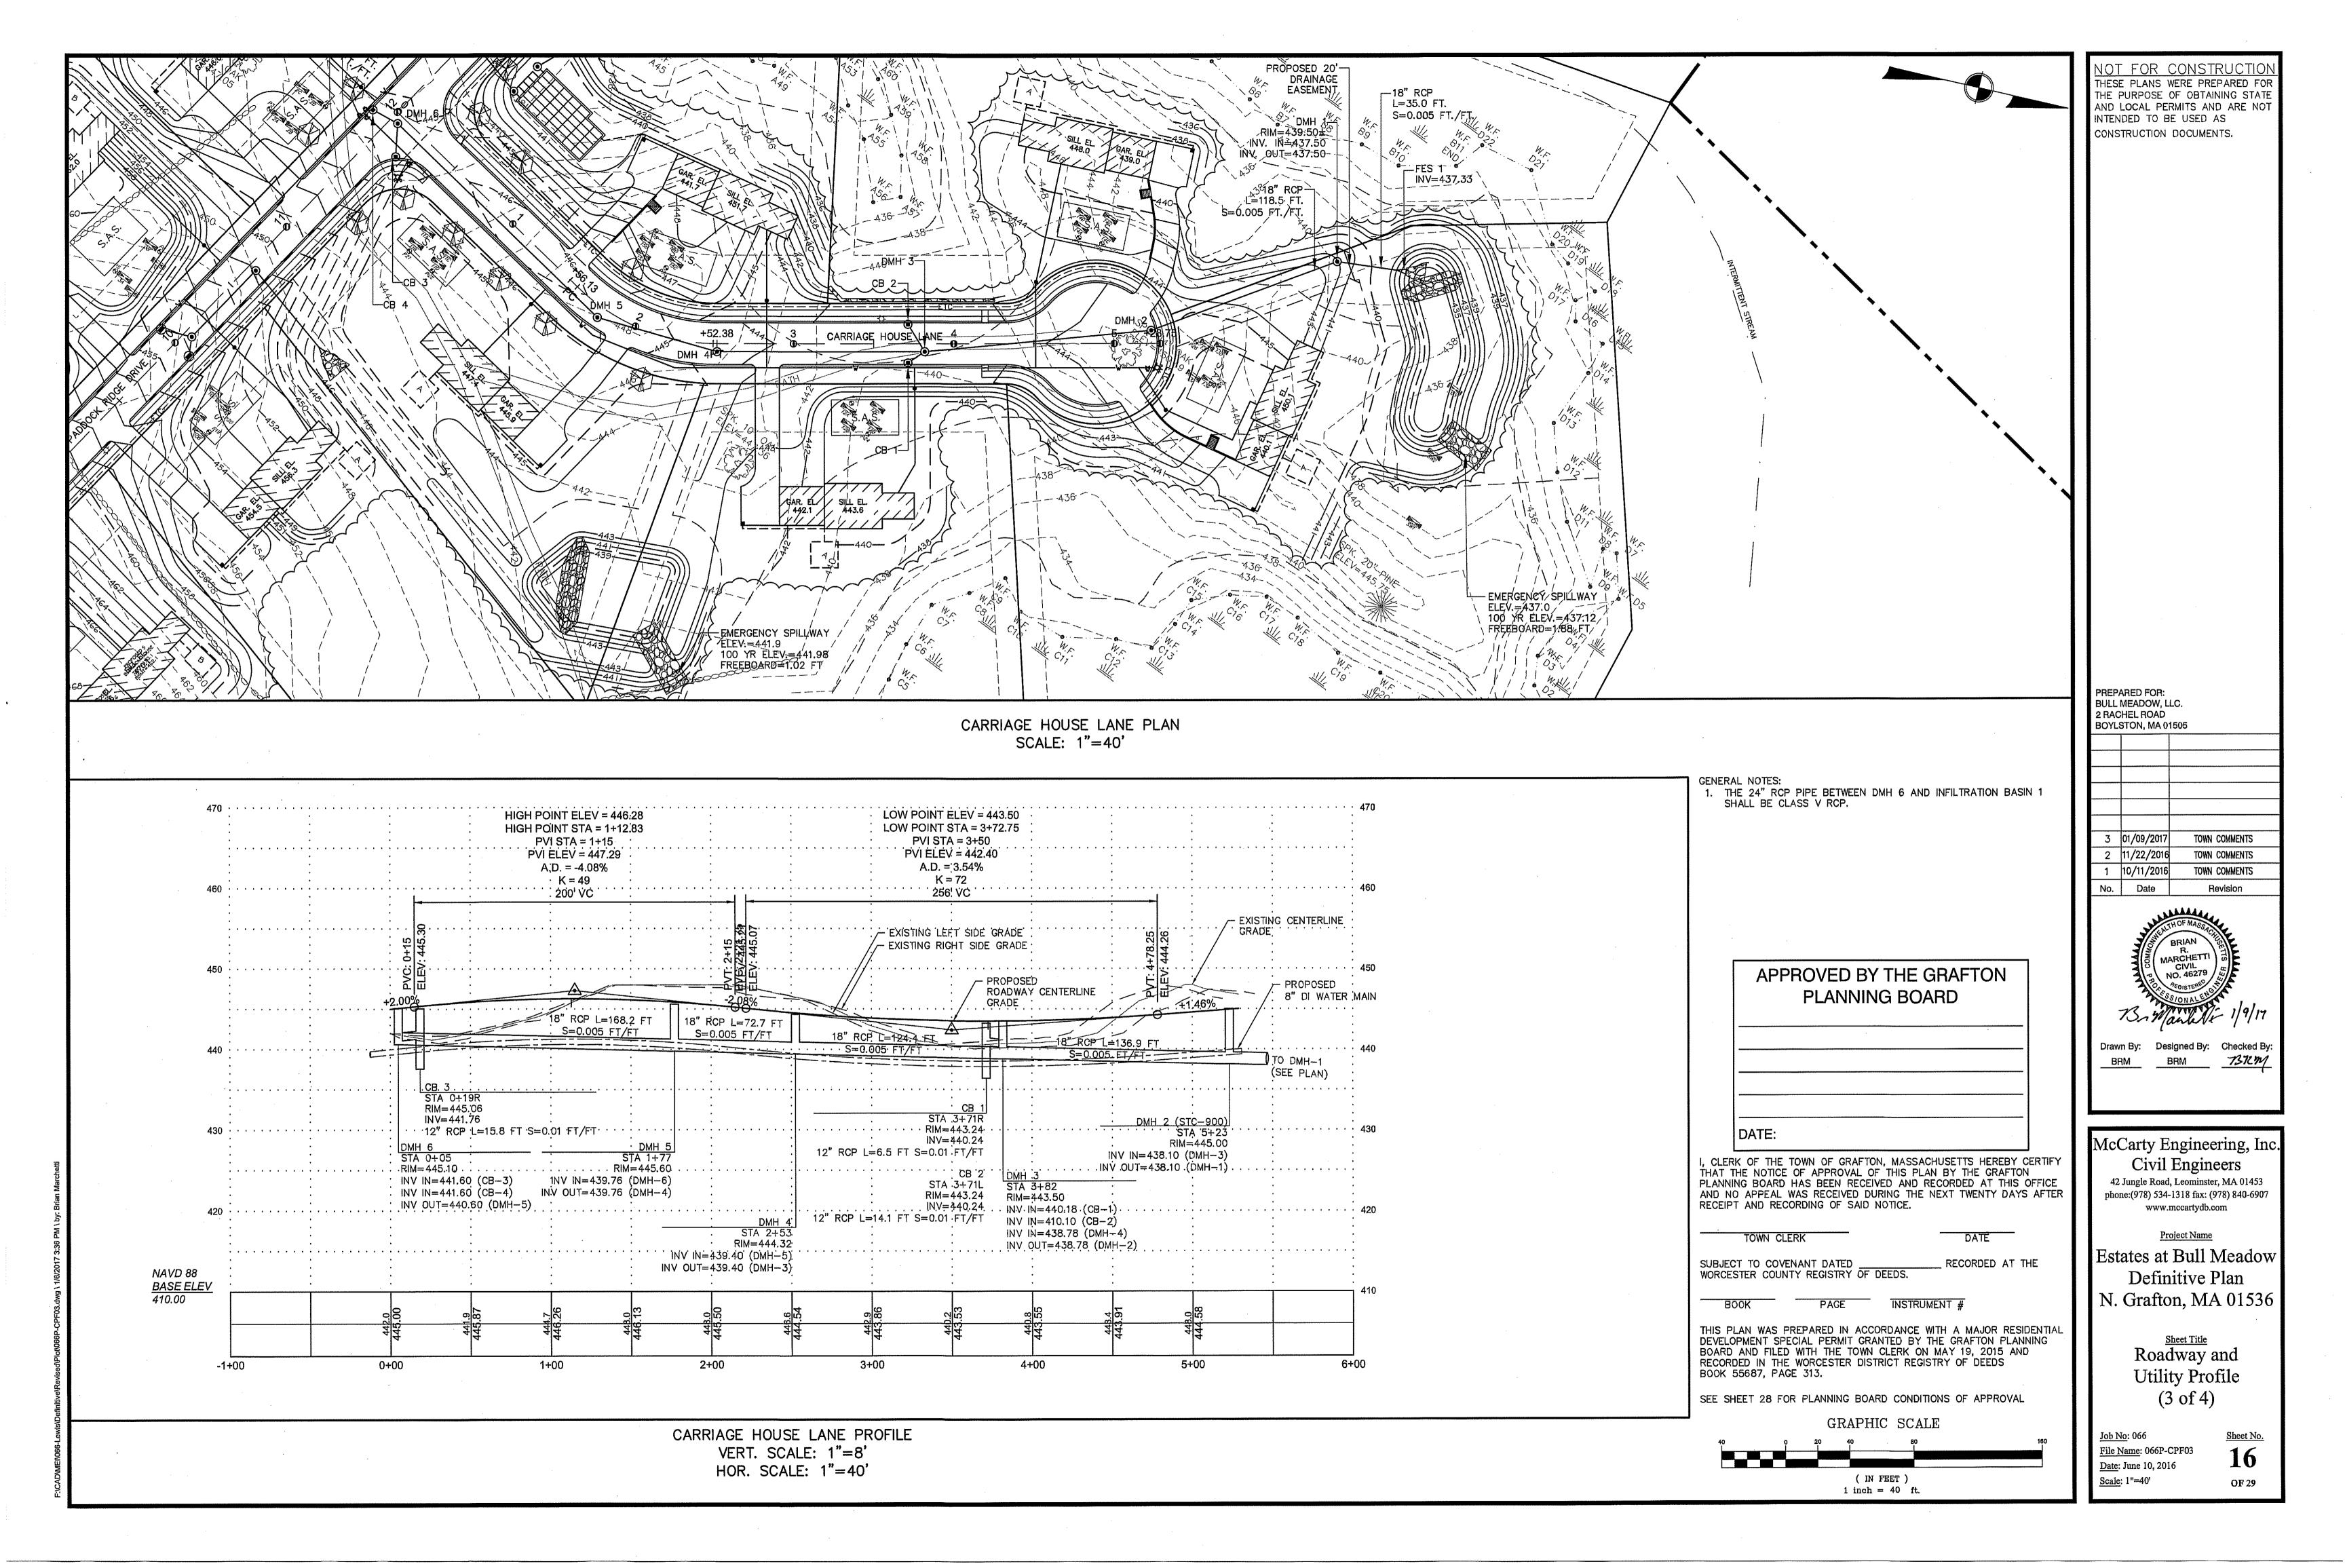

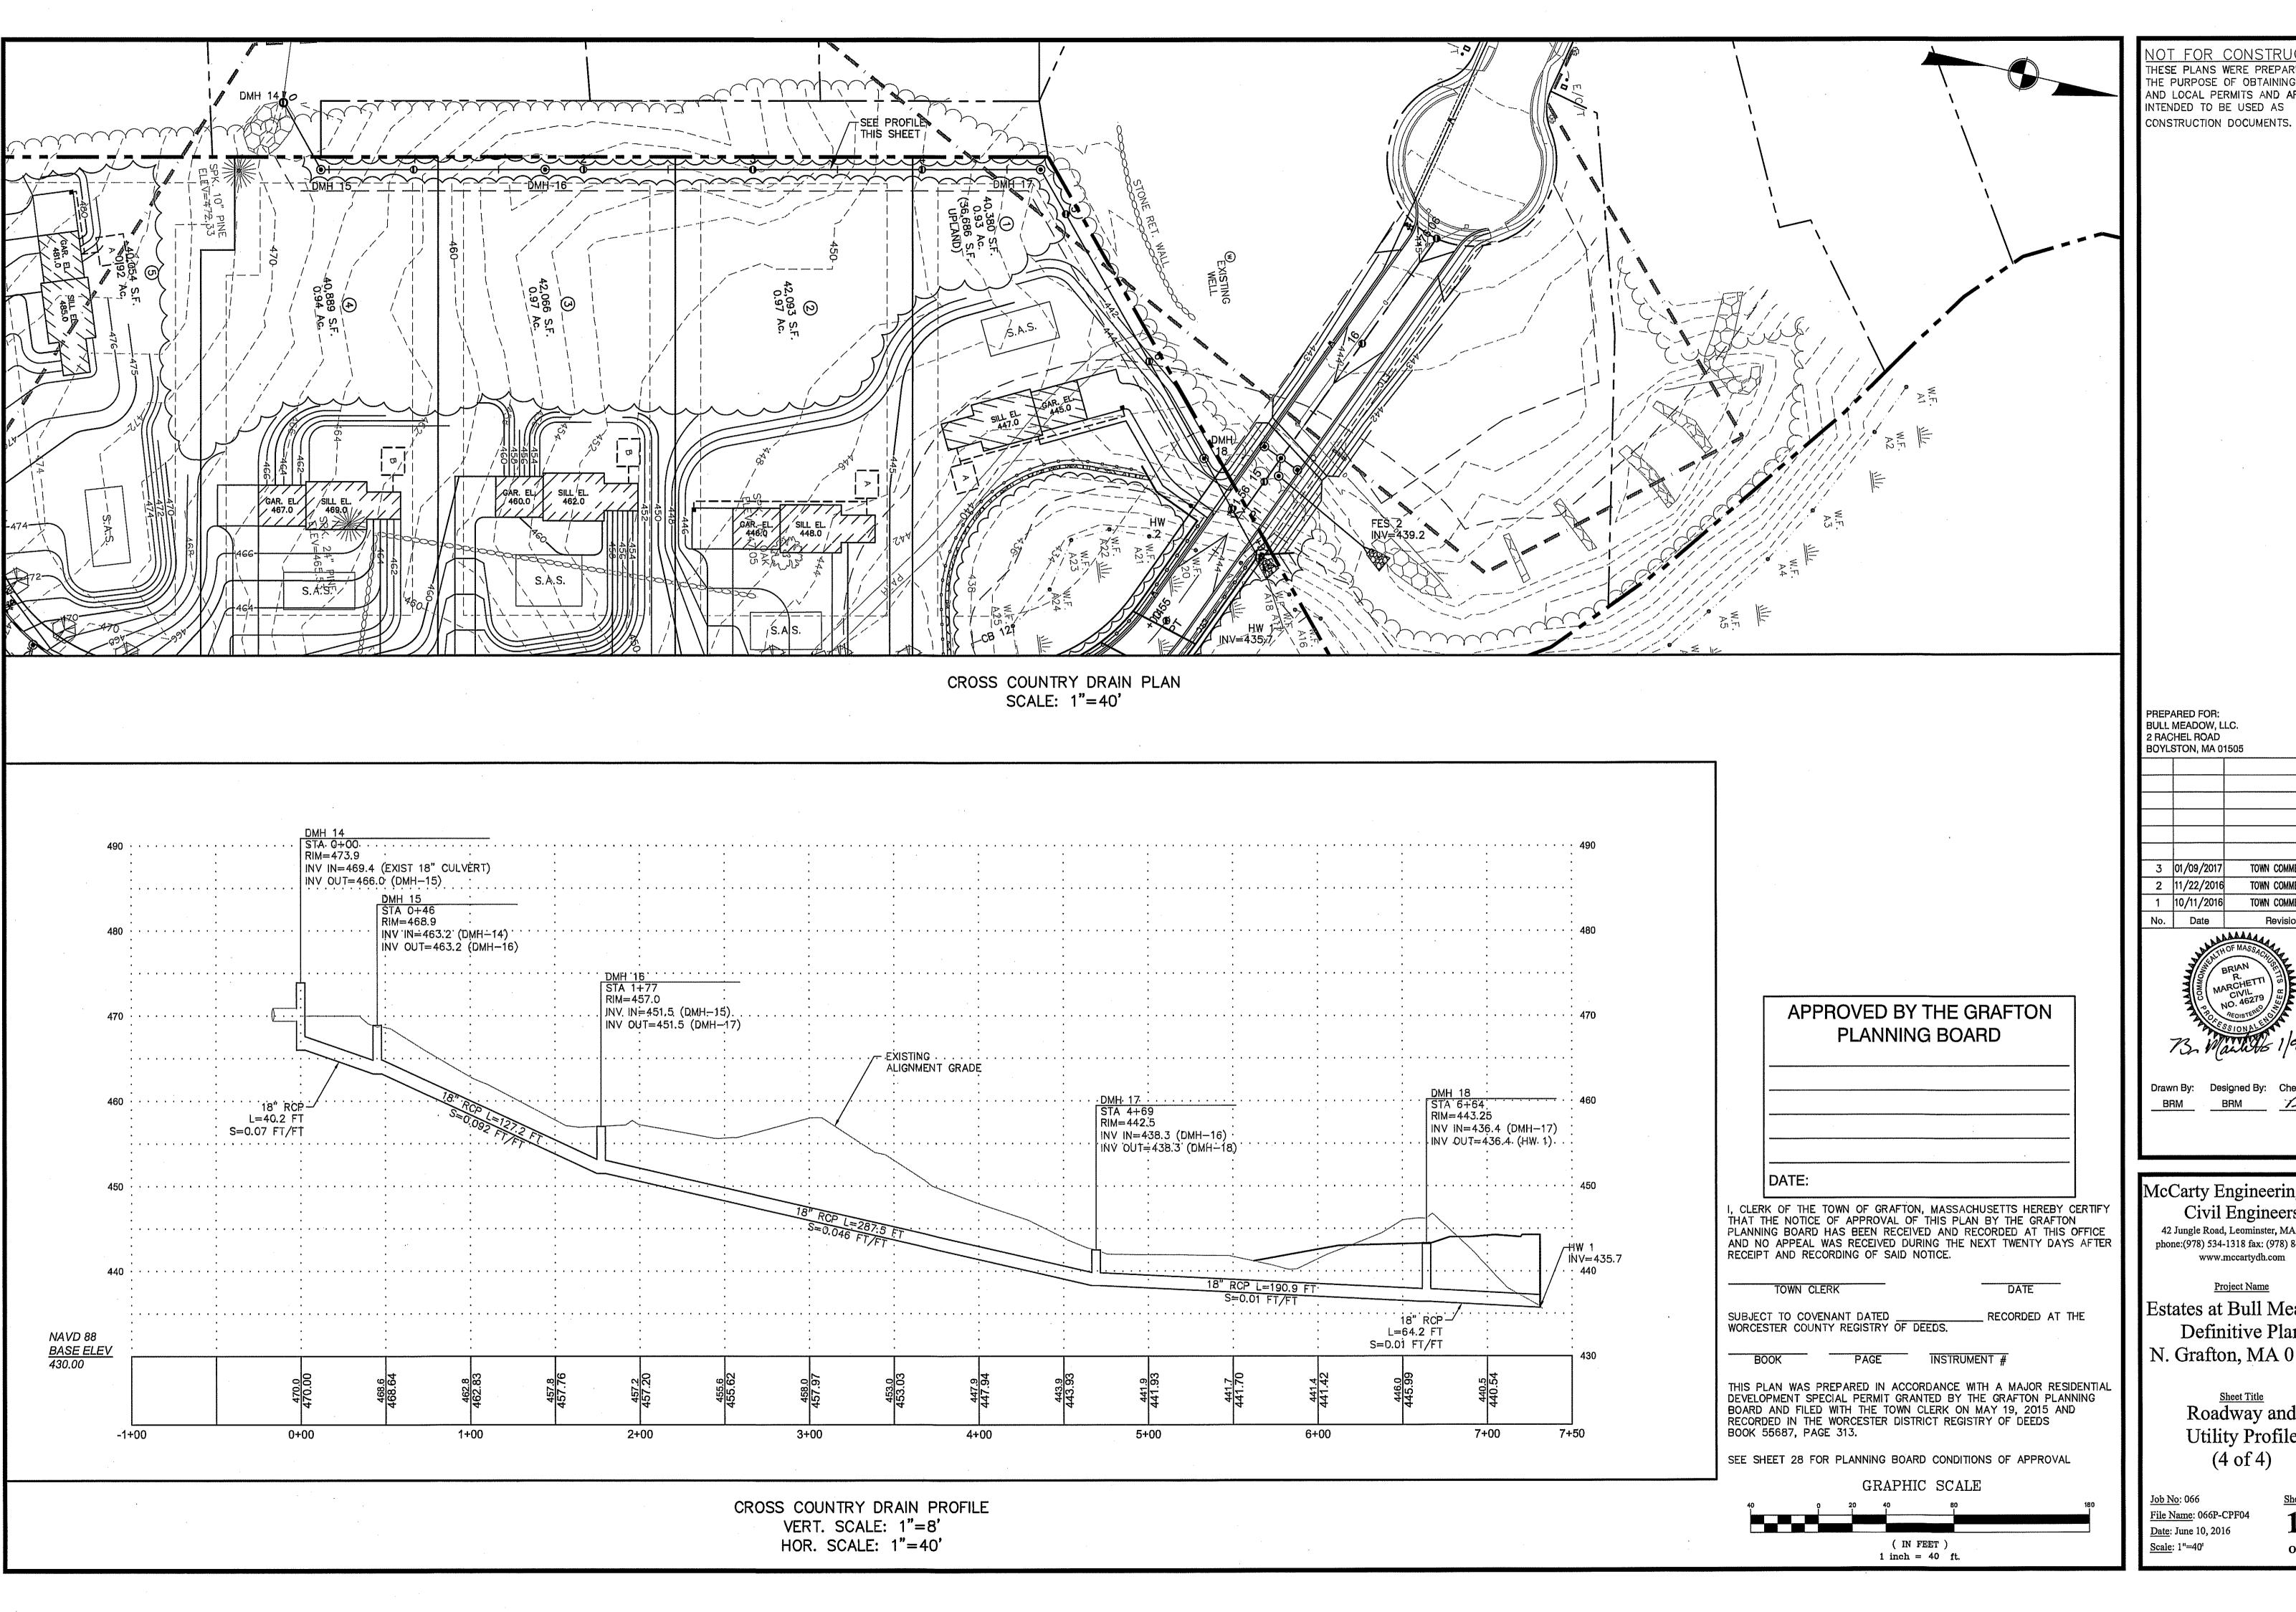


AND LOCAL PERMITS AND ARE NOT INTENDED TO BE USED AS


TOWN COMMENTS TOWN COMMENTS


McCarty Engineering, Inc. Civil Engineers 42 Jungle Road, Leominster, MA 01453 phone:(978) 534-1318 fax: (978) 840-6907


Estates at Bull Meadow Definitive Plan N. Grafton, MA 01536

> Roadway and Utility Profile

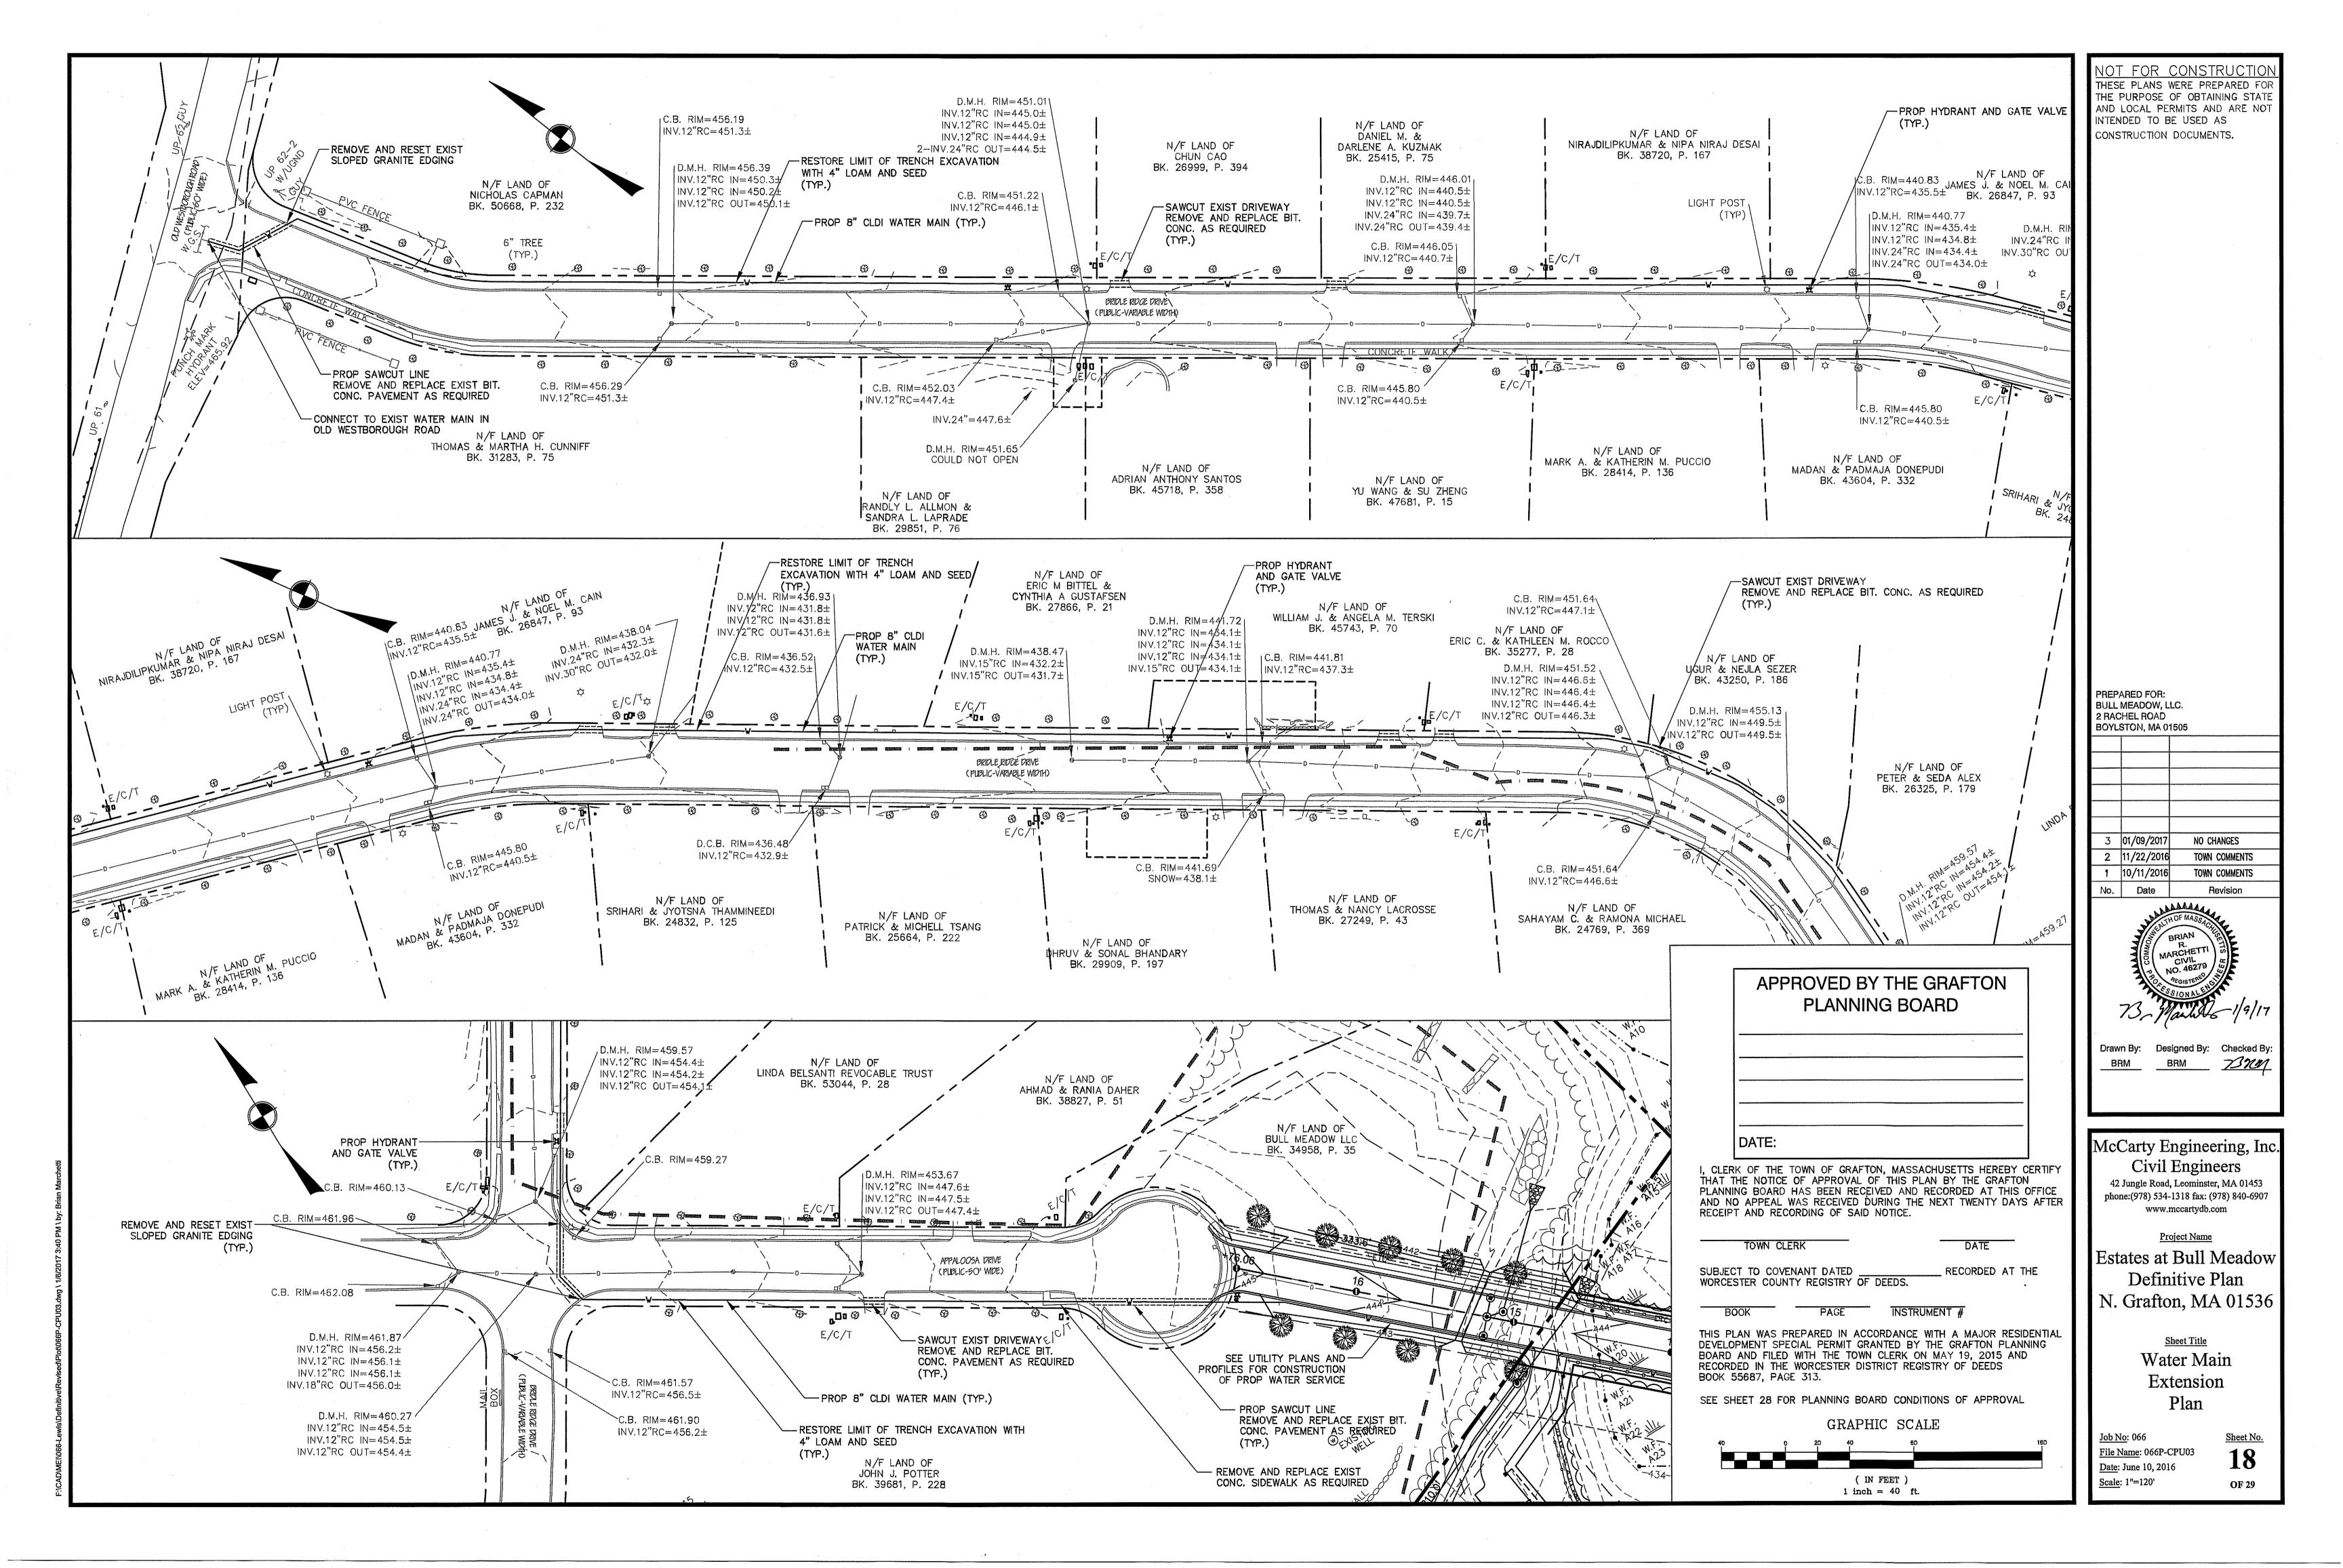

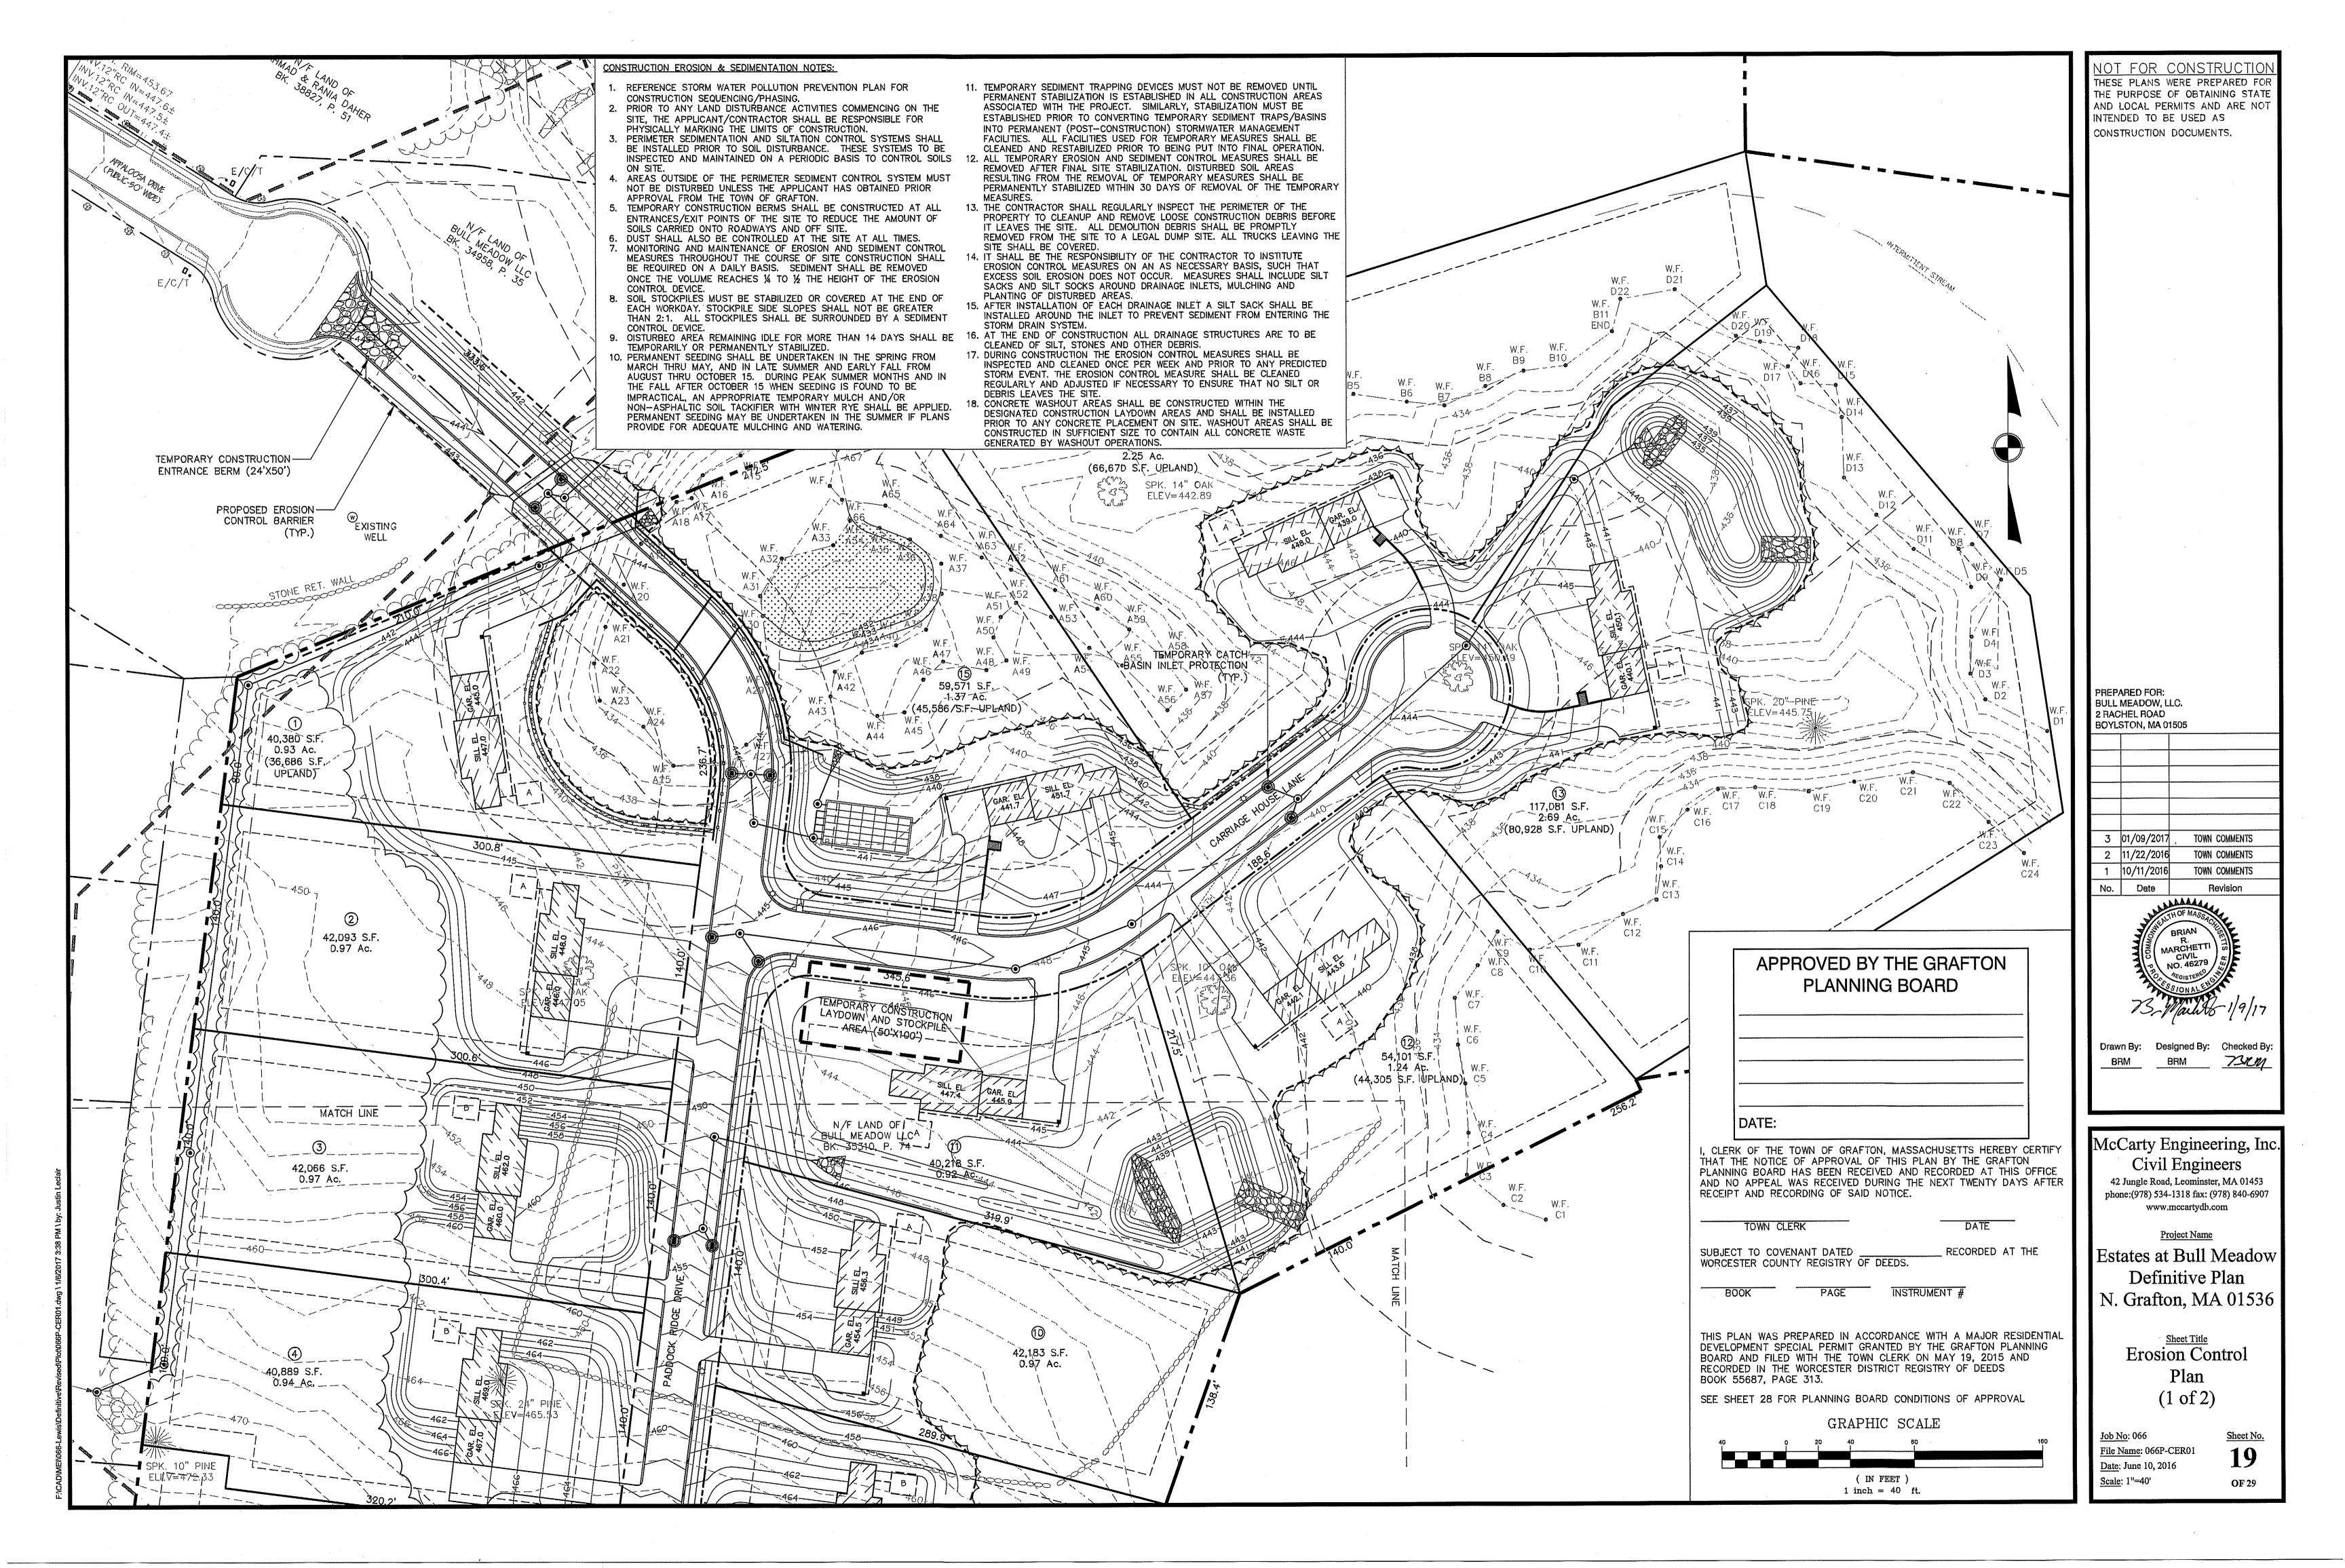

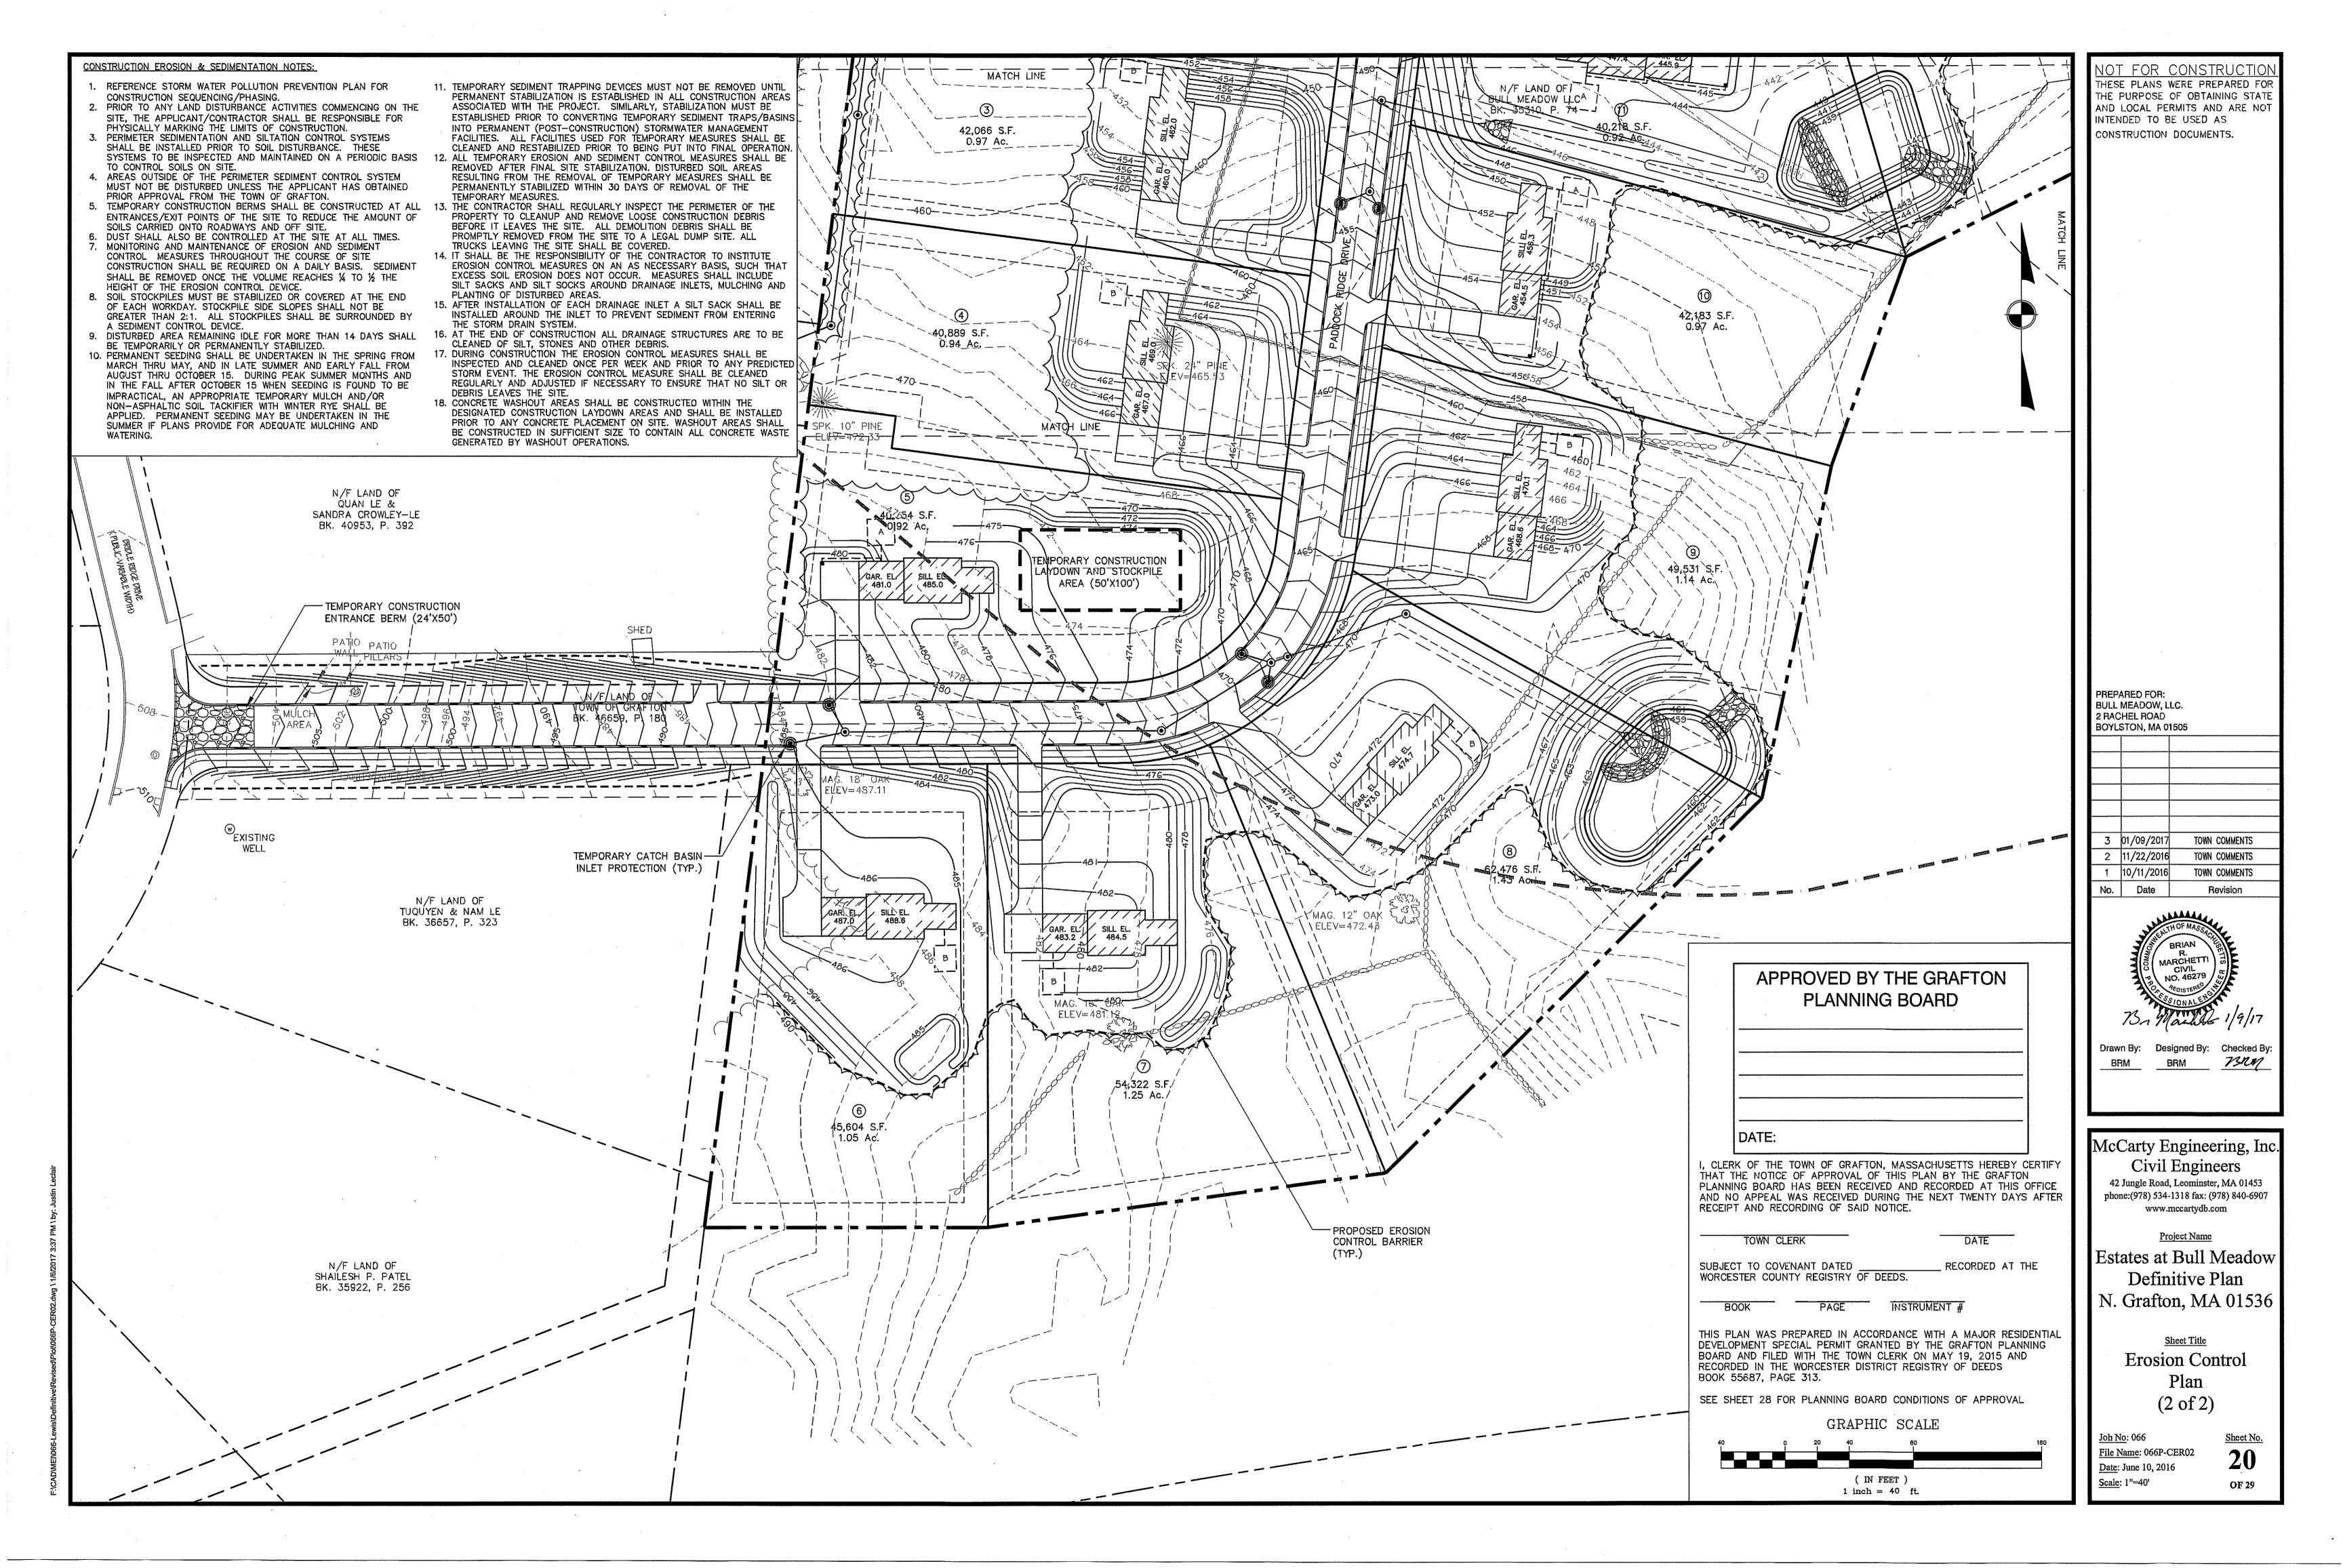

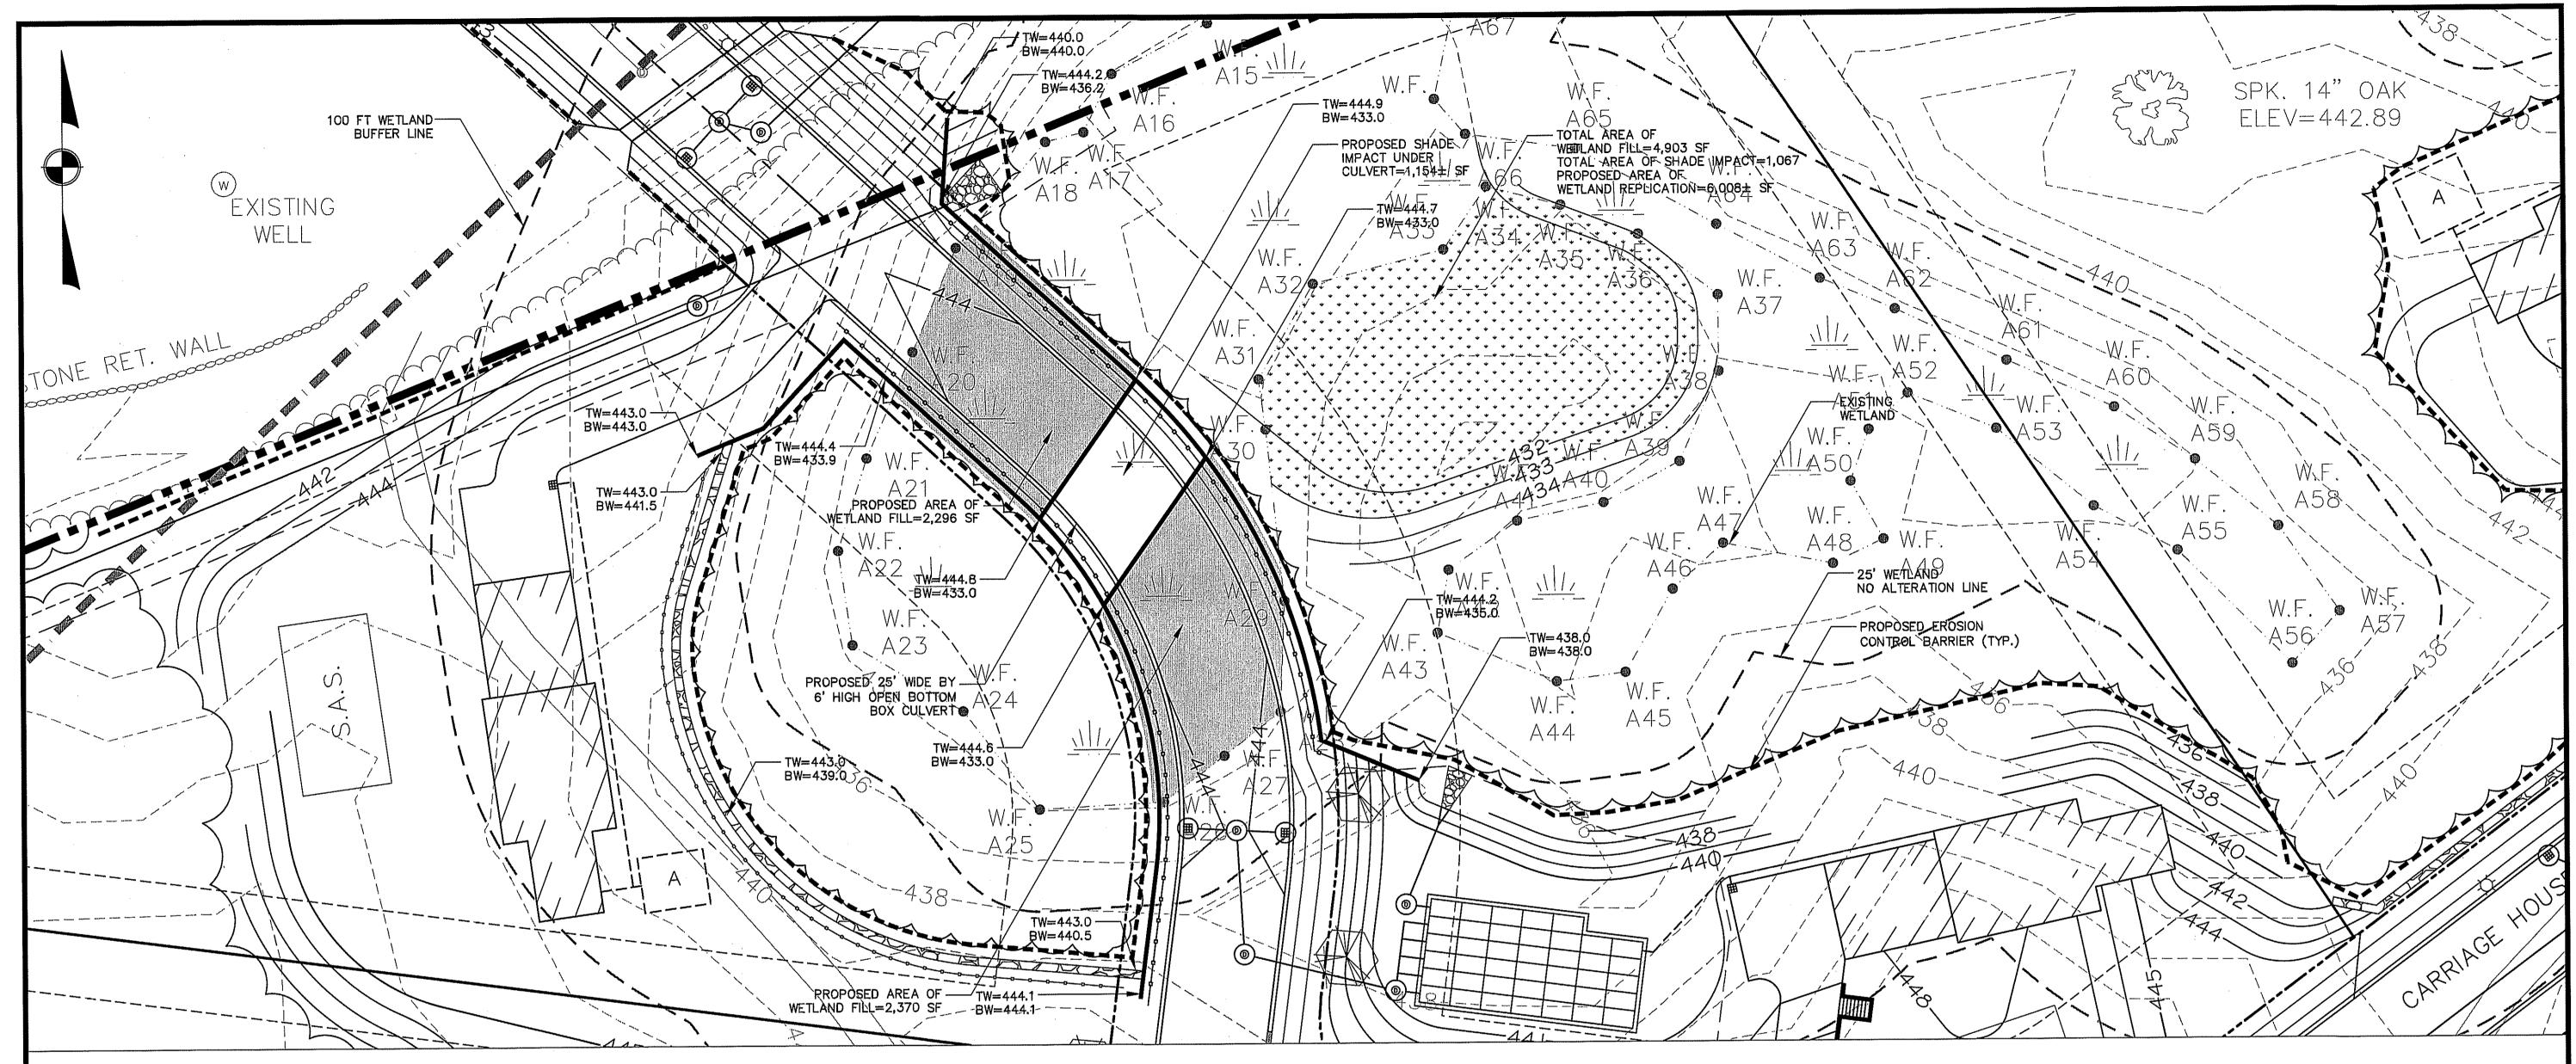

BORDERING VEGETATED WETLAND REPLICATION CONSTRUCTION PROTOCOL:

- 1. THE FOLLOWING PROTOCOL CONFORMS TO THE GENERAL STANDARDS IN THE MA WETLANDS PROTECTION ACT REGULATIONS AT 310 CMR 10.55(4)(b)
- 2. THE WETLAND BOUNDARIES (I.E., DOWNGRADIENT EDGES OF THE WETLAND REPLICATION AREA) WILL BE MARKED IN THE FILED.
- 3. PRIOR TO THE START OF EARTH-MOVING ACTIVITIES IN THE REPLICATION AREA, AN EROSION CONTROL BARRIER OF PROPERLY INSTALLED SILTATION FENCE (I.E, THE BOTTOM FEW INCHES OF THE SILTATION FENCE INSTALLED IN A NARROW, TRENCH AND THE TRENCH FILLED WITH SOIL AROUND THE SILTATION FENCE) WILL BE INSTALLED ALONG THE WETLAND BOUNDARIES BETWEEN THE WETLAND AND THE WETLAND REPLICATION AREA. THE WETLAND REPLICATION AREA WILL THEN BE CLAEARED AND GRUBBED, WITH THE EXCEPTION OF THE TREES THAT HAVE BEEN MARKED TO BE SAVED.
- 4. THE PROPOSED FINAL GRADE OF THE REPLICATION AREA SHOULD APPROXIMATE THE ELEVATION OF THE ADJACENT WETLAND AREAS (432±), AS NOTED ON THE SITE PLANS. THE REPLICATION AREA WILL BE EXCAVATED TO A DEPTH OF 12 INCHES BELOW THE PROPOSED FINAL GRADE. THE EXCAVATION AND PLANTING WORK WILL BE CLOSELY SUPERVISED BY A QUALIFIED WETLAND SCIENTIST. MINOR MODIFICATIONS TO THE PROPOSED GRADING MAY BE MADE IN THE FILE BY THE WETLAND SCIENTIST IN RESPONSE TO OBSERVED SUBSURFACE HYDROLOGIC CONDITIONS. ALL EXCAVATED MATERIAL WILL BE DISPOSED OF AWAY FROM ALL WETLAND RESOURCE AREAS.
- 5. EXISTING TOPSOIL WITHIN THE IMPACT AREA WILL BE EXCAVATED, STOCKPILED AND KEPT MOIST BY WATERING AND/OR COVERING OR IMMEDIATELY TRANSPORTED TO THE REPLICATION AREA.
- 6. RELOCATED WETLAND TOPSOIL WILL BE SUPPLEMENTED WITH A 1:1 MIXTURE OF HIGH QUALITY, LOAMY TOPSOIL AND LEAF MOLD COMPOST, AS NECESSARY, TO APPROXIMATE 12 INCHES IN THICKNESS THROUGHOUT THE REPLICATION AREA. THE TOPSOIL SHALL HAVE A MINIMUM OF 9% ORGANIC MATTER. THE SUBSTRATE WILL BE ROUGHLY GRADED TO PROVIDE AN APPROPRIATE MICROTOPOGRAPHY. A MINIMUM OF 4 INCHES OF LOAMY TOPSOIL WILL BE APPLIED TO THE SIDE—SLOPES OF THE WETLAND REPLICATION AREA. THE SIDE SLOPES SHOULD BE STABILIZED AS NECESSARY TO PREVENT EROSION.
- 7. AN EROSION CONTROL BARRIER COMPRISING ONLY TOED—IN SILTATION FENCE WILL BE PROPERLY INSTALLED BETWEEN THE COMPLETED REPLICATION AREA AND THE ADJACENT UPLAND SIDE SLOPES.

- 8. PLANTING WILL BE DONE ONLY DURING THE BEGINNING (APRIL 15 THROUGH JUNE) OR END (SEPTEMBER 1 TO NOVEMBER 15) OF THE GROWING SEASON. PLANTING IN THE MID—GROWING SEASON IS ONLY ACCEPTABLE IF IRRIGATION IS PROVIDED. THE PLANTINGS AND SEED MIXTURE IDENTIFIED IN THE FOLLOWING TABLE WILL BE PLANTED IN THE REPLICATION AREA UNLESS THE HERBACEOUS LAYER CAN BE TRANSPLANTED INTO THE REPLICATION AREA.
- THE REPLICATION AREA WILL BE MULCHED WITH 1 TO 2 INCHES OF LEAF COMPOST OR WEED FREE STRAW TO PROVIDE FOR TEMPORARY EROSION CONTROL AND MOISTURE RETENTION.
- 10. THE SIDE—SLOPES OF THE WETLAND REPLICATION AREA WILL BE SEEDED WITH A GRASS/WILDFLOWER OR CONSERVATION MIXTURE DESIGNED TO PROVIDE PERMANENT COVER, AFTER SEEDING, THE SIDE—SLOPES WILL BE MULCHED WITH A THIN LAYER OF STRAW TO PROVIDE FOR TEMPORARY EROSION CONTROL.
- 11. THE REPLICATION AREAS WILL BE INSPECTED, BY A QUALIFIED WETLAND SCIENTIST, AT THE END OF EACH GROWING SEASON FOR A MINIMUM OF THREE YEARS OR UNTIL SUCH TIME AS THE REQUIRED 75% OF VEGETATIVE COVER WITH WETLAND SPECIES HAS BEEN ESTABLISHED. WRITTEN RESULTS OF THESE INSPECTIONS WILL BE SUBMITTED TO THE CONSERVATION COMMISSION. INVASIVE SPECIES WITHIN THE REPLICATION AREA OR WITHIN 25—FEET OF THE REPLICATION AREA SHALL BE HAND PULLED OR CUT.
- 12. AFTER THE WETLAND REPLICATION AREA HAS BECOME VEGETATIVELY STABILIZED AND FOLLOWING APPROVAL OF THE ISSUING AUTHORITY, THE SILTATION FENCE AND ALL WOODEN STAKES WILL BE REMOVED AND DISPOSED OF PROPERLY.

#### PLANTING PLAN FOR WETLAND REPLICATION AREA:

SPECIES: SIZE: SPACING:	NUMBER:
SAPLINGS; 6 TO 8' HEIGHT, CONTAINER OR BALLED, BURLAPPED; 15' ON—CENTER AVERAGE	
RED MAPLE (ACER RUBRUM)	26
SHRUBS; 2.5 TO 3' IN HEIGHT, CONTAINER, 6' ON—CENTER AVERAGE SPACING	167 TOTAL*
HIGHBUSH BLUEBERRY (VACCINIUM CORYMBOSUM)	
NANNYBERRY (VIBURNAM LENTAGO)	
WINTERBEERRY (ILEX VERTICILLATA)	
SILKY DOGWOOD (CORNUS AMOMUM)	
HERBACEOUS (PLUGS, SEED OF PLUGS NOT AVAILABLE)	
TUSSOCK SEDGE (CAREX STRICTA)	38
JOE-PYE-WEED (EUPATORIUM MACULATUM/PURPUREUM)	38
BONESET (EUPATORIUM PERFOLIATUM)	38
LURID SEDGE (CAREX LURIDA)	38
SOFT RUSH (JUNCUS EFFUSES)	38
SENSITIVE FERN (ONOCLEA SENSIBILIS)	10
NEW ENGLAND WETLAND PLANTS, NEW ENGLAND WETMIX (OR EQUIVALENT)	2.0 lbs.
	AFOL ODEOLEO

\* DEPENDING UP AVAILABILITY FROM LOCAL NURSERY STOCK, THESE SPECIES MAY BE SUBSTITUTED WITH SIMILAR NATIVE SPECIES

#### WETLAND CROSSING SEQUENCE OF WORK:

- INSTALL EROSION CONTROL BARRIER (ECB) AT LOCATION SHOWN ON PLAN.
- INSTALL ADDITIONAL ECB PROTECTION THROUGH SECTION OF WETLAND AT PROPOSED CULVERT.
- CLEAR TREES IN WORK AREA WITHOUT CROSSING EQUIPMENT OVER THE SECTION OF WETLAND TO REMAIN.
- ALL WORK IS TO BE ACCESSED FROM EITHER SIDE OF THE PROPOSED CROSSING. ONLY FOOT
- TRAFFIC IS PERMITTED IN RESOURCE AREA.
- REMOVE & DISPOSE STUMPS.
- STRIP & STOCKPILE WETLAND SOILS TO BE USED IN REPLICATION AREA. IF WITHIN 100FT WETLAND BUFFER STOCKPILE SHOULD BE SURROUNDED IN HAYBALES & COVERED IN 4 MIL POLY.
- FORM & POUR CONCRETE FOOTING FOR OPEN BOTTOM CULVERT.
- INSTALL CULVERT & ANCHOR TO FOOTING.
   PREPARE CRUSHED STONE BASE FOR PRECAST
- CONCRETE BLOCK RETAINING WALLS.
- IF DEWATERING IS REQUIRED:
   USE ELECTRIC SUBMERSIBLE PUMP.
- •• USE SUFFICIENT HOSE LENGTHS TO PUMP TO TEMP DRAINAGE SWALE.
- •• CONSTRUCT 10X10X1' APRON OF 6-12" RIP RAP AT DISCHARGE POINT.
- •• PERIODICALLY INSPECT DISCHARGE POINT & SWALE FOR BUILDUP OF SEDIMENT.
- IMPORT, PLACE, & COMPACT STRUCTURAL FILL BETWEEN WALLS.

INSTALL PRECAST CONCRETE BLOCK WALLS.

- CONTINUE WITH WALL CONSTRUCTION & FILL
- PLACEMENT TO SUBGRADE.

   INSTALL TEMPORARY FENCE AT TOP OF WALL.
- INSTALL TEMPORARY FENCE AT TOP OF V
   INSTALL UTILITIES IN CROSSING AREA.
- INSTALL GRAVEL FOR ROADWAY BASE.
- INSTALL BINDER COURSE OF PAVEMENT.
- INSTALL BINDER COORSE OF PAV
   INSTALL GRANITE CURBING.
- CONSTRUCT CONCRETE SIDEWALK.
- INSTALL GUARDRAIL & FENCING.
   LOAM & HYDROSEED SHOULDERS.
- PROCEED WITH CONSTRUCTION OF WETLAND REPLICATION AREA.

# APPROVED BY THE GRAFTON PLANNING BOARD

	,		
DATE:			

I, CLERK OF THE TOWN OF GRAFTON, MASSACHUSETTS HEREBY CERTIFY THAT THE NOTICE OF APPROVAL OF THIS PLAN BY THE GRAFTON PLANNING BOARD HAS BEEN RECEIVED AND RECORDED AT THIS OFFICE AND NO APPEAL WAS RECEIVED DURING THE NEXT TWENTY DAYS AFTER RECEIPT AND RECORDING OF SAID NOTICE.

TOWN CLERK


RECORDED AT THE

SUBJECT TO COVENANT DATED \_\_\_\_\_ RECORDED AT WORCESTER COUNTY REGISTRY OF DEEDS.

BOOK PAGE INSTRUMENT #

THIS PLAN WAS PREPARED IN ACCORDANCE WITH A MAJOR RESIDENTIAL DEVELOPMENT SPECIAL PERMIT GRANTED BY THE GRAFTON PLANNING BOARD AND FILED WITH THE TOWN CLERK ON MAY 19, 2015 AND RECORDED IN THE WORCESTER DISTRICT REGISTRY OF DEEDS BOOK 55687, PAGE 313.

SEE SHEET 28 FOR PLANNING BOARD CONDITIONS OF APPROVAL

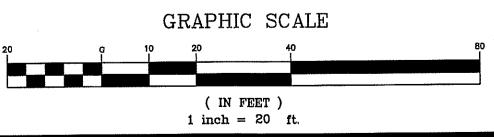

1 11/22/2016 TOWN COMMENTS

No. Date Revision

BRIAN R. MARCHETTI CIVIL NO. 46279

PROSTRERED BRIAN R. SOLUTION OF MASSACHE BRIAN R. MARCHETTI CIVIL NO. 46279

Drawn By: Designed By: Checked By: JLL BRM 75.744

TOWN COMMENTS

BULL MEADOW, LLC. 2 RACHEL ROAD BOYLSTON, MA 01505

2 01/09/2017

AND LOCAL PERMITS AND ARE

INTENDED TO BE USED AS

CONSTRUCTION DOCUMENTS.

McCarty Engineering, Inc.
Civil Engineers

42 Jungle Road, Leominster, MA 01453 phone:(978) 534-1318 fax: (978) 840-6907 www.mccartydb.com

Project Name

Estates at Bull Meadow Definitive Plan N. Grafton, MA 01536

Wetland Crossing

Replication Area Plan

<u>Job No</u>: 066

<u>File Name</u>: 066P-WRA01

Date: October 11, 2016

Scale: 1"=20'

A01 Sheet No.
21
OF 29

- LIMIT OF CLEARING TO BE MARKED OUT FOR ENTIRE PROJECT.
- INSTALL EROSION CONTROL BARRIER AND CONSTRUCTION ENTRANCE. CUT TREES & CHIP - CHIPS TO BE HAULED OFF
- REMOVE & DISPOSE STUMPS. STUMPS CAN BE

GROUND ON-SITE AND GRINDING TO BE HAULED

- OFF SITE. WHOLE STUMPS CAN BE HAULED OFFSITE TO A DISPOSAL FACILITY. STRIP AND STOCKPILE TOP & SUBSOIL. MAINTAIN A STOCKPILE ON SITE, OUTSIDE OF THE 100 FT
- BUFFER ZONE, SUFFICIENT TO LOAM LOTS AND DISTURBED AREAS AT THE COMPLETION OF CONSTRUCTION. EXCESS LOAM CAN BE HAULED OFF SITE.
- COMPLETE ROUGH GRADING OF THE SITE TO ESTABLISH SUBGRADE. INFILTRATION BASINS 1,2,3,4 SHALL BE ESTABLISHED TO WITHIN 1FT OF FINISH GRADE. CONSTRUCT TEMPORARY SWALES AS NEEDED TO DIRECT RUNOFF TO THE INFILTRATION BASINS. BASINS SHOULD BE MONITORED THROUGHOUT THE CONSTRUCTION PROCESS TO ENSURE THAT THEY DO NOT BECOME SILTED UP.
- STARTING WITH CROSS COUNTRY DRAINAGE THAT ... PICKS UP DISCHARGE FROM THE NORTH GRAFTON ESTATES DETENTION BASIN. ONCE CROSS COUNTRY DRAIN IS COMPLETE, DRAINAGE IMPROVEMENTS SHOULD BE INSTALLED STARTING AT THE INFILTRATION BASINS AND WORKING UPSTREAM. AS EACH CATCHBASIN IS INSTALLED, IT SHOULD BE EQUIPPED WITH A CATCHBASIN INLET FILTER. FILTERS SHOULD BE INSPECTED
- REGULARLY & CLEANED AS NEEDED. INSTALLATION OF WETLANDS CROSSING: SEE SEPARATE SCOPE OF WORK ON WETLAND CROSSING AND REPLICATION AREA PLAN.
- INSTALLATION OF WATER MAINS & SERVICE
- INSTALLATION OF ELECTRIC CONDUIT.

STUBS.

- INSTALLATION OF ROADWAY GRAVEL.
- INSTALLATION OF BINDER COURSE OF PAVEMENT.
- INSTALLATION OF CURBING. ONCE BINDER COURSE OF PAVEMENT & CURBS ARE INSTALLED, WORK CAN PROCEED ON THE

INDIVIDUAL HOUSE LOTS.

- LOTS WERE CLEARED, STUMPED & STRIPPED AS PART OF ROADWAY CONSTRUCTION
  - SEQUENCE EXCAVATE FOR FOUNDATIONS. FORM & POUR CONCRETE FOUNDATION. EXCAVATE PIT FOR WASHOUT OF TRUCK TOOLS & EQUIPMENT.
  - BACKFILL FOUNDATION. SUB-GRADING OF LOT. HOUSE CONSTRUCTION: FRAME, ROOF, SIDE,

HYDROSEED.

- INTERIOR CONSTRUCTION ETC. INSTALLATION OF SEPTIC SYSTEM. INSTALLATION OF WATER SERVICE.
- INSTALLATION OF UNDERGROUND ELECTRIC INSTALLATION OF GAS SERVICE.
- FINAL GRADING OF LOT. INSTALLATION OF GRAVEL FOR DRIVEWAY. INSTALLATION OF HARDSCAPES (WALKWAYS,
- PATIOS, ETC.). PAVE BINDER COURSE OF DRIVEWAY. LOAM & LANDSCAPE INSTALLATION. INSTALLATION OF TOP COAT OF DRIVEWAY.

- . FINAL SHAPING OF INFILTRATION BASINS, INSTALLATION OF FOREBAYS, ETC.
- INSTALLATION OF STREET TREES.
- INSTALLATION OF FENCING.
- INSTALLATION OF SCREENED LOAM ON ALL REMAINING DISTURBED AREAS.
- CLEAN & INSPECT ALL ROADWAY SURFACES.

CLEAR ALL CATCHBASIN SUMPS & FILTERS.

- INSTALLATION OF TOP COURSE OF PAVEMENT & SIGNAGE.
- PREPARE AS—BUILT PLANS.

- •• CUT & PATCH ANY DAMAGED SECTIONS OF
- SAWCUT CONTROL JOINTS WHERE NEW ROADS MEET EXISTING ROADS.

PREPARE CRUSHED STONE BASE FOR PRECAST

CONCRETE BLOCK RETAINING WALLS. NOTE IF DEWATERING IS REQUIRED:

USE ELECTRIC SUBMERSIBLE PUMP. USE SUFFICIENT HOSE LENGTHS TO PUMP TO TEMP DRAINAGE SWALE.

CONSTRUCT 10X10X1' APRON OF 6-12" RIP RAP AT DISCHARGE POINT. PERIODICALLY INSPECT DISCHARGE POINT & SWALE FOR BUILDUP OF SEDIMENT.

- INSTALL PRECAST CONCRETE BLOCK WALLS. • IMPORT. PLACE, & COMPACT STRUCTURAL FILL BETWEEN WALLS.
- CONTINUE WITH WALL CONSTRUCTION & FILL PAVEMENT TO SUBGRADE. INSTALL TEMPORARY FENCE AT TOP OF WALL.
- INSTALL UTILITIES IN CROSSING AREA.
- INSTALL GRAVEL FOR ROADWAY BASE.
- INSTALL BINDER COURSE OF PAVEMENT.
- INSTALL GRANITE CURBING.
- CONSTRUCT CONCRETE SIDEWALK.
- INSTALL GUARDRAIL & FENCING.
- LOAM & HYDROSEED SHOULDERS. PROCEED WITH CONSTRUCTION OF WETLAND REPLICATION AREA.

LOCUS PLAN 1"=1,500 FT.±

LEGEND:

PROPOSED LOT NUMBER

PHASE 1 WATERLINE EXTENSION TO OLD WESTBOROUGH RD.

> PHASE 2 ROADWAY/DRAINAGE/UTILITY CONSTRUCTION

PHASE 3 WETLAND CROSSING

APPROVED BY THE GRAFTON **PLANNING BOARD** DATE:

. CLERK OF THE TOWN OF GRAFTON. MASSACHUSETTS HEREBY CERTIFY THAT THE NOTICE OF APPROVAL OF THIS PLAN BY THE GRAFTON PLANNING BOARD HAS BEEN RECEIVED AND RECORDED AT THIS OFFICE AND NO APPEAL WAS RECEIVED DURING THE NEXT TWENTY DAYS AFTER RECEIPT AND RECORDING OF SAID NOTICE.

DATE TOWN CLERK RECORDED AT THE SUBJECT TO COVENANT DATED WORCESTER COUNTY REGISTRY OF DEEDS.

THIS PLAN WAS PREPARED IN ACCORDANCE WITH A MAJOR RESIDENTIAL DEVELOPMENT SPECIAL PERMIT GRANTED BY THE GRAFTON PLANNING BOARD AND FILED WITH THE TOWN CLERK ON MAY 19, 2015 AND RECORDED IN THE WORCESTER DISTRICT REGISTRY OF DEEDS BOOK 55687, PAGE 313.


INSTRUMENT #

BOOK PAGE

SEE SHEET 28 FOR PLANNING BOARD CONDITIONS OF APPROVAL

GRAPHIC SCALE ( IN FEET ) 1 inch = 100 ft.

THESE PLANS WERE PREPARED FOR THE PURPOSE OF OBTAINING STATE AND LOCAL PERMITS AND ARE NOT INTENDED TO BE USED AS CONSTRUCTION DOCUMENTS.

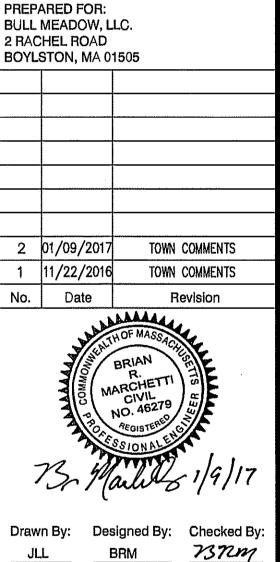

McCarty Engineering, Inc. Civil Engineers

42 Jungle Road, Leominster, MA 01453 phone:(978) 534-1318 fax: (978) 840-6907 www.mccartydb.com

Project Name

Estates at Bull Meadow Definitive Plan N. Grafton, MA 01536


Sbeet Title **Construction Phasing** Plan

File Name: 066P-CSPP01 <u>Date</u>: October 11, 2016 Scale: 1"=100'

OF 29

- 2. ALL COMPACTION TO A MINIMUM 95 PERCENT DRY DENSITY DETERMINED BY ASTM D1557 3. ALL PRECAST TO MEET OR EXCEED ASTM C-478 AND ASSHTO M 199 SPECIFICATIONS 4. REINFORCED STEEL TO MEET OR EXCEED ASTM A185 AND H-20 LOADING REQUIREMENTS 5. ALL PRECAST CONCRETE TO BE 4,000 PSI MIMIMUM AND MEET ASTM C-478 (6.1)
- 6. IF NO STEPS ARE SPECIFIED THAN AS THE LOCAL MUNICIPALITY REQUIRES OR IF NO MUNICIPLAITY REQUIREMENTS THEN COPOLYMER POLYPROPYLENE COATED REINFORCED PER ASTM C-478 AND OSHA (STD 1-1.9)
- 7. CONTRACTOR TO CONFIRM WITH CITY OR TOWN DPW THAT BRICK INVERTS ARE NOT A
- 8. FILL ALL INTERNAL AND EXTERNAL HOLES WITH NON-SHRINK GROUT

#### PRECAST CONCRETE DRAIN MANHOLE DETAIL

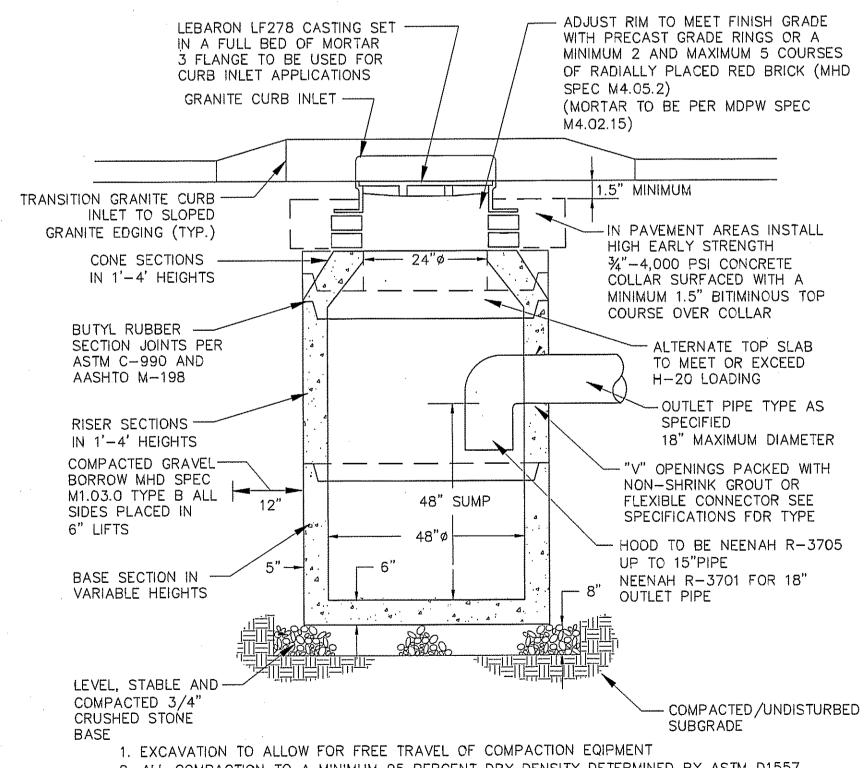


- 2. ALL COMPACTION TO A MINIMUM 95 PERCENT DRY DENSITY DETERMINED BY ASTM D1557 3. ALL PRECAST TO MEET OR EXCEED ASTM C-478 AND ASSHTO M 199 SPECIFICATIONS
- 4. REINFORCED STEEL TO MEET OR EXCEED ASTM A185 AND H-20 LOADING REQUIREMENTS 5. ALL PRECAST CONCRETE TO BE 4,000 PSI MIMIMUM AND MEET ASTM C-478 (6.1)
- 6. ALL INTERIOR HOLES TO BE SEALED WITH NON-SHRINK GROUT 7. MIN. STRUCTURE DEPTH SHALL BE 7.5 FT.

#### PRECAST CONCRETE CATCH BASIN DETAIL


N.T.S.

TYPICAL ROADWAY 4' CHAIN LINK -CROSS SECTION FENCE SET IN (SEE MINOR STREET B RETAINING WALL CROSS SECTION DETAIL) 6.0 RIGHT-OF-WAY LINE PRECAST CONCRETE -MODULAR BLOCK MINIMUM: RETAINING WALL ELEC/TEL/CABLE 3" MINUS COVER COMPACTED (STONE STRONG OR 30" MIN COVER QO STRUCTURAL FILL APPROVED EQUAL) --- PROPOSED DOUBLE 그는 그는 그는 그는 그는 그는 그는 그들은 그 하는 가는 그는 그는 그는 그는 그는 그는 그들은 그들은 그들은 그들은 그들은 그들은 그를 가는 것이다. 그는 그들은 그를 하는 그를 모르는 그 STAKED HAYBALE AND SILT FENCE. - 6'X25' OPEN-EXISTING WETLAND -BOTTOM CULVERT -8" CLDI WATER MAIN INSULATE OVER CULVERT CROSSING

> WETLAND CROSSING CROSS SECTION SCALE: 1"=50"

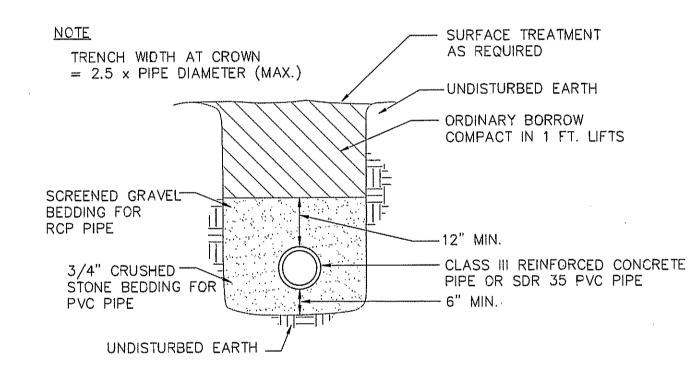

#### DRAIN PIPE TRENCH DETAIL

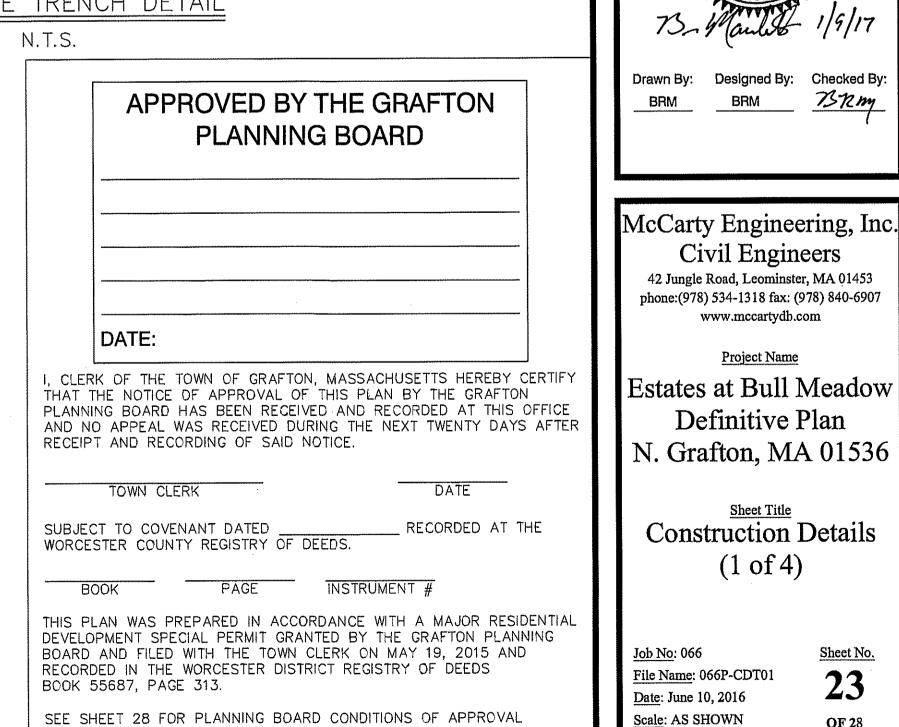

WOOD GUARD RAIL DETAIL

N.T.S.

THE PURPOSE OF OBTAINING STATE AND LOCAL PERMITS AND ARE NOT INTENDED TO BE USED AS CONSTRUCTION DOCUMENTS. -6"x6" P.T. WOOD RAIL HEX NUT W/ROUND WASHER (STEEL) -5/8" RAIL BOLT 16" LONG 1 PER POST, MIN. 2" THREAD -6"x8" P.T. POST

BULL MEADOW, LLC. 2 RACHEL ROAD BOYLSTON, MA 01505					
3	01/09/2017	NO	CHANGE		
2	11/22/2016		COMMENTS		
1	10/11/2016	TOWN	COMMENTS		
No.	Date	F	Revision		
7	<b>4</b> 1" 1	ACHETTI CIVIL NO. 46279 AEGISTERES SSIONALES	/ Urlb.		

PREPARED FOR:

NOT FOR CONSTRUCTION THESE PLANS WERE PREPARED FO

McCarty Engineering, Inc. Civil Engineers


42 Jungle Road, Leominster, MA 01453 phone: (978) 534-1318 fax: (978) 840-6907 www.mccartydb.com

Project Name Estates at Bull Meadow Definitive Plan

> Construction Details (1 of 4)

File Name: 066P-CDT01 Date: June 10, 2016 Scale: AS SHOWN

Sheet No.

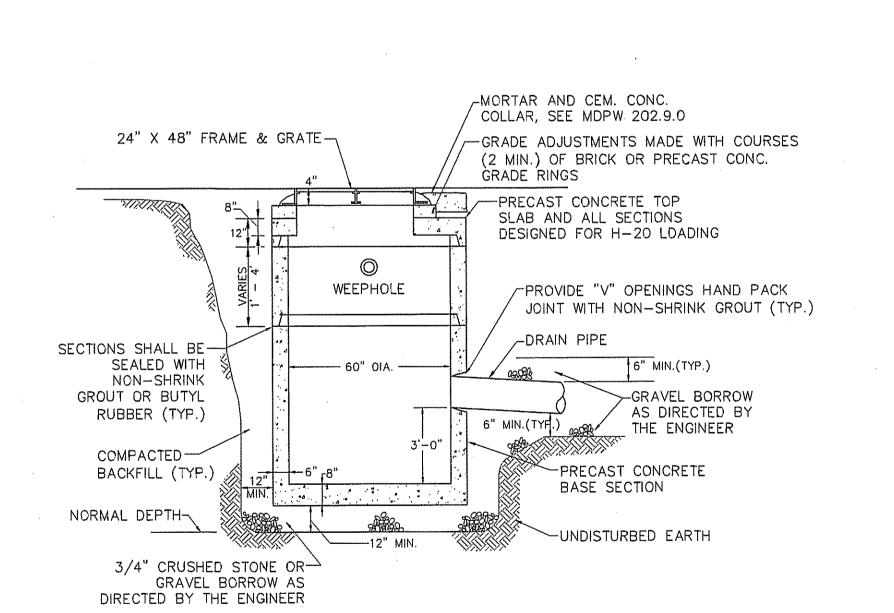


CATCH BASIN SHALL BE PRECAST CEMENT CONCRETE MANUFACTURED IN ACCORDANCE WITH ASTM C-478 DESIGNED FOR H-20 LOADING.

- 2. DRAIN PIPE FOR LATERAL CONNECTIONS SHALL BE INSTALLED AND TEMPORARILY PLUGGED AS REQUIRED OR DIRECTED.
- 3. SEE GENERAL PLANS FOR PIPE SIZE, LINE AND GRADE.
- 4. BACKFILL MATERIAL SHALL CONSIST OF SUITABLE EXCAVATED MATERIAL AND/OR GRAVEL BORROW AS DIRECTED BY THE ENGINEER.
- 5. INSTALL FRAME & GRATE WITH 24" SIDE ALONG CURB INLET.


#### PRECAST CONCRETE DOUBLE CATCH BASIN DETAIL

N.T.S.

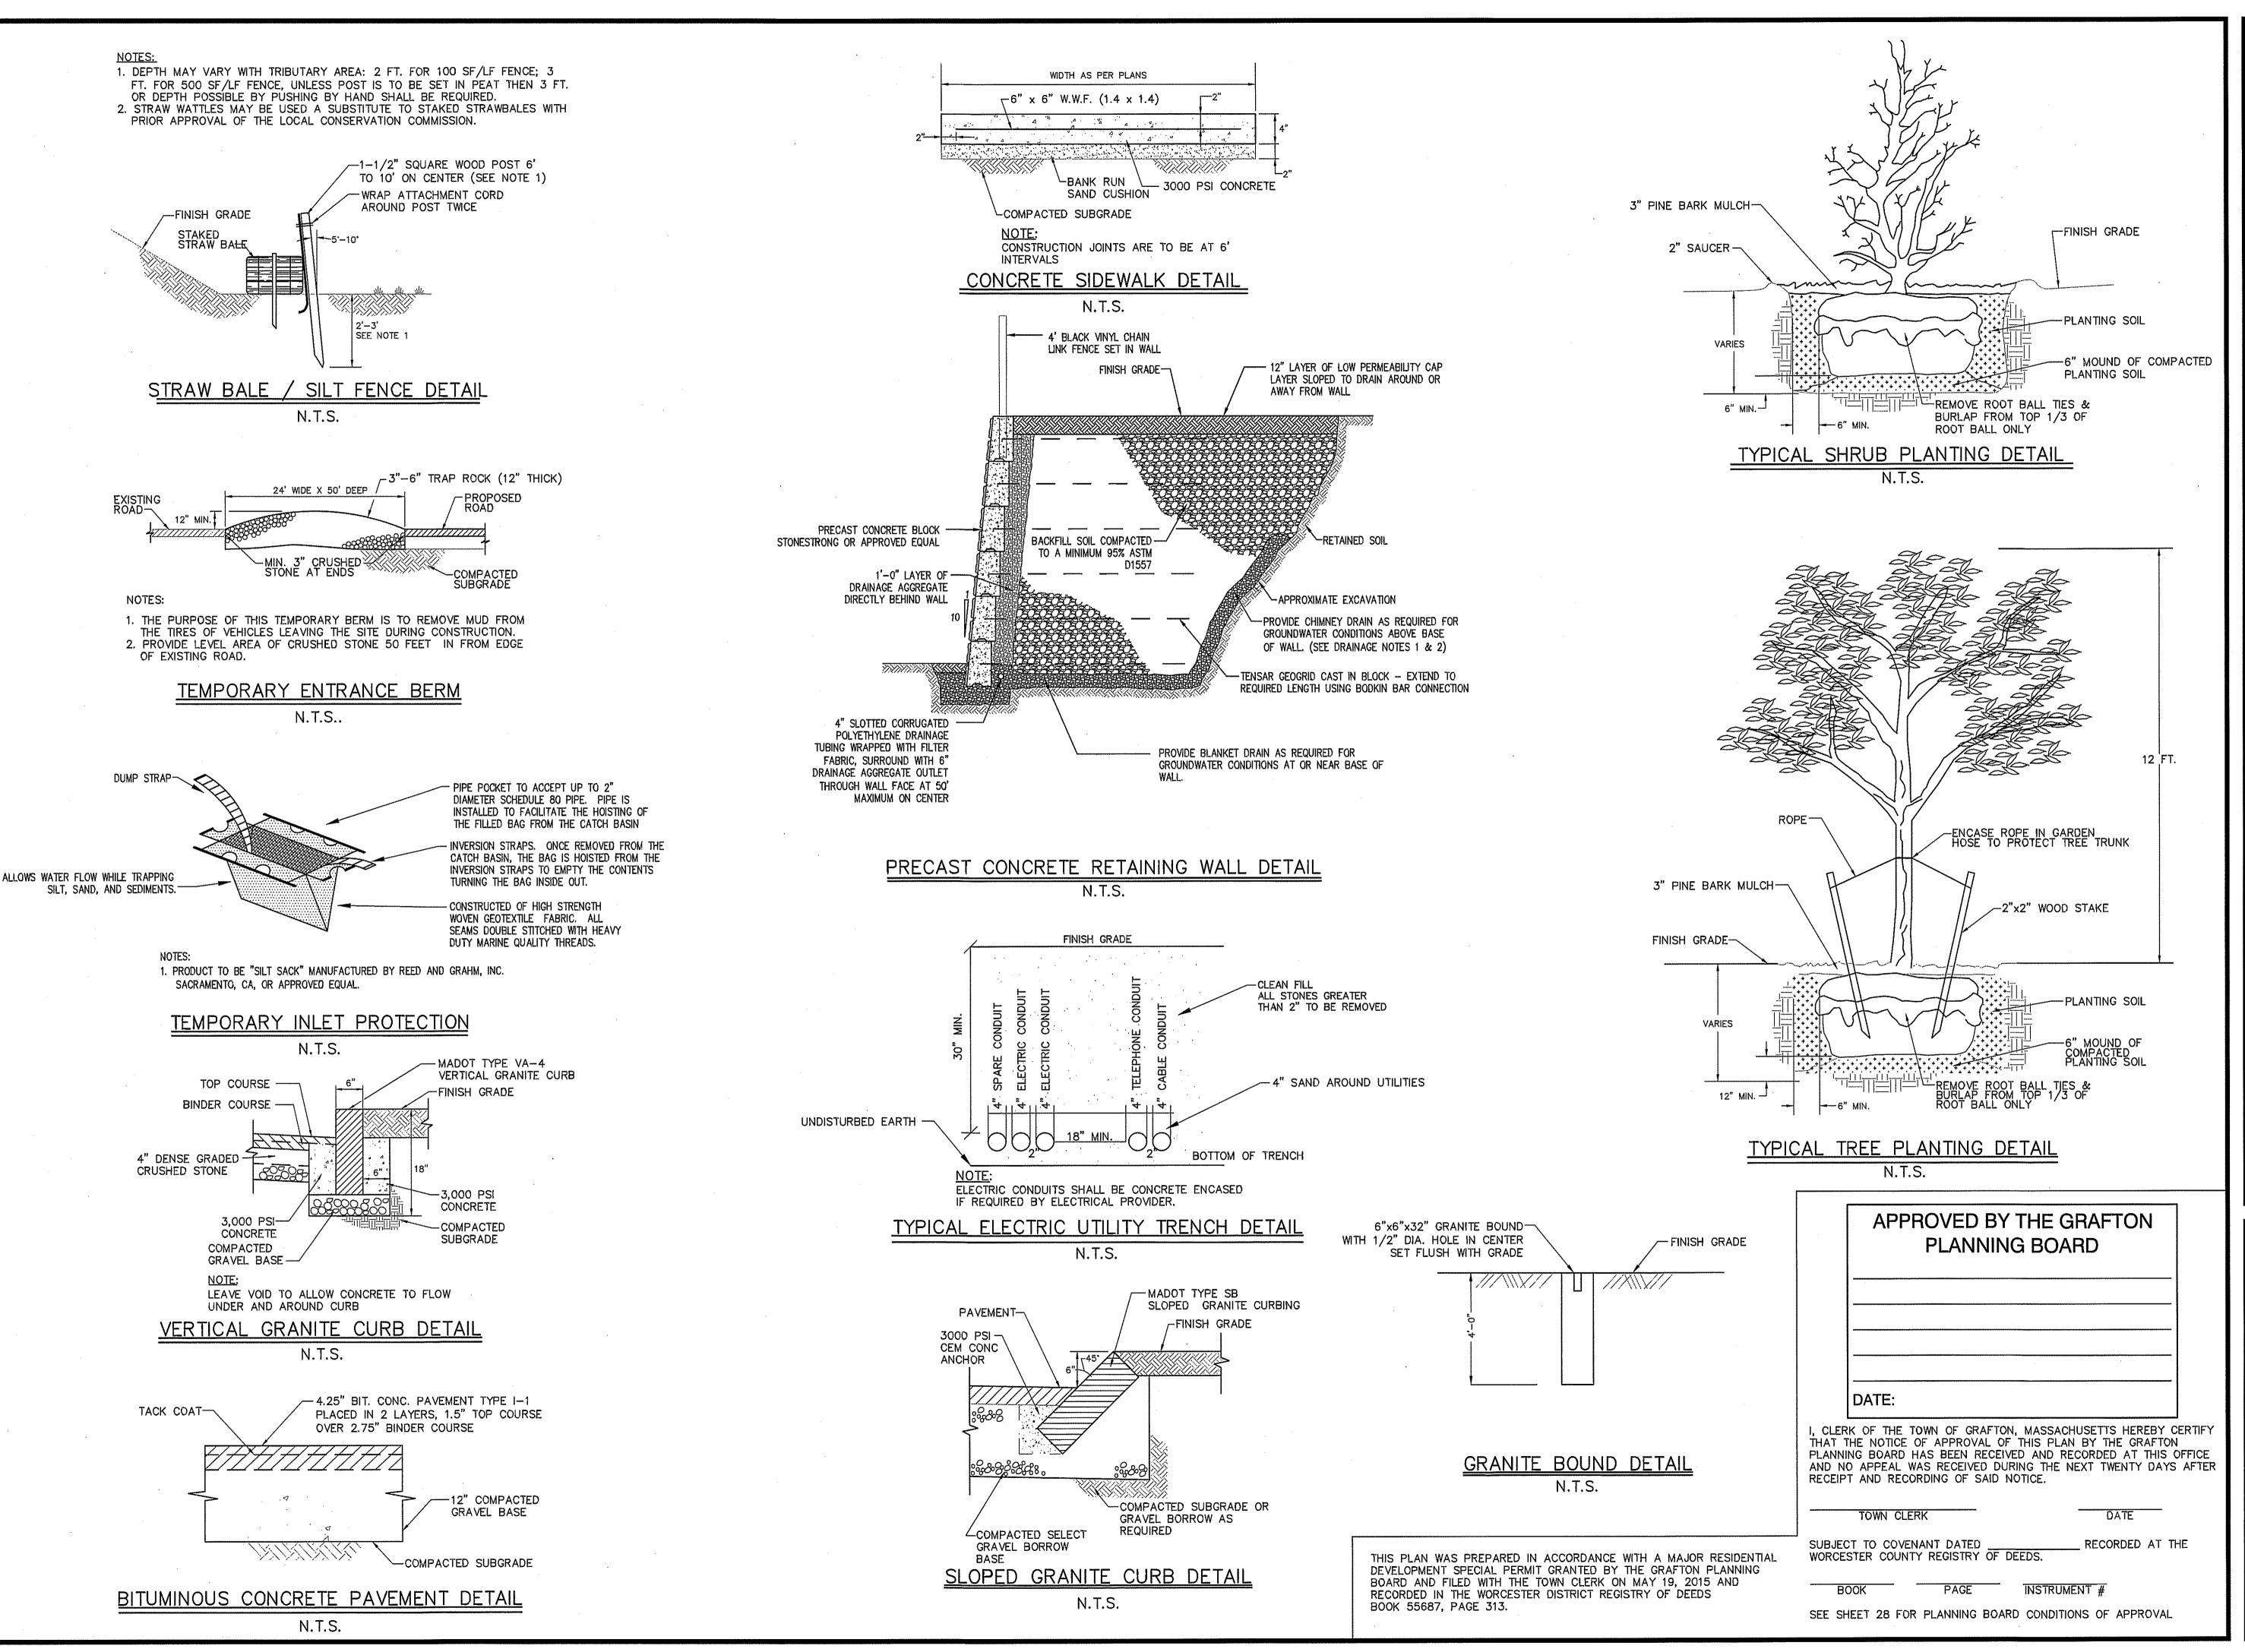

NOT FOR CONSTRUCT THESE PLANS WERE PREPARED FO THE PURPOSE OF OBTAINING STATE AND LOCAL PERMITS AND ARE NOT INTENDED TO BE USED AS CONSTRUCTION DOCUMENTS.

> PREPARED FOR: BULL MEADOW, LLC. 2 RACHEL ROAD BOYLSTON, MA 01505 3 01/09/2017 NO CHANGE 2 11/22/2016 TOWN COMMENTS

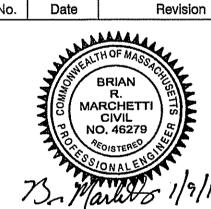

TOWN COMMENTS

1 10/11/2016

Designed By: Checked By BRM

McCarty Engineering, Inc. Civil Engineers 42 Jungle Road, Leominster, MA 01453 phone:(978) 534-1318 fax: (978) 840-6907 www.mccartydb.com


Project Name


Estates at Bull Meadow Definitive Plan N. Grafton, MA 01536


> Sheet Title Construction Details (2 of 4)

File Name: 066P-CDT02 Date: June 10, 2016

Sheet No. Scale: AS SHOWN

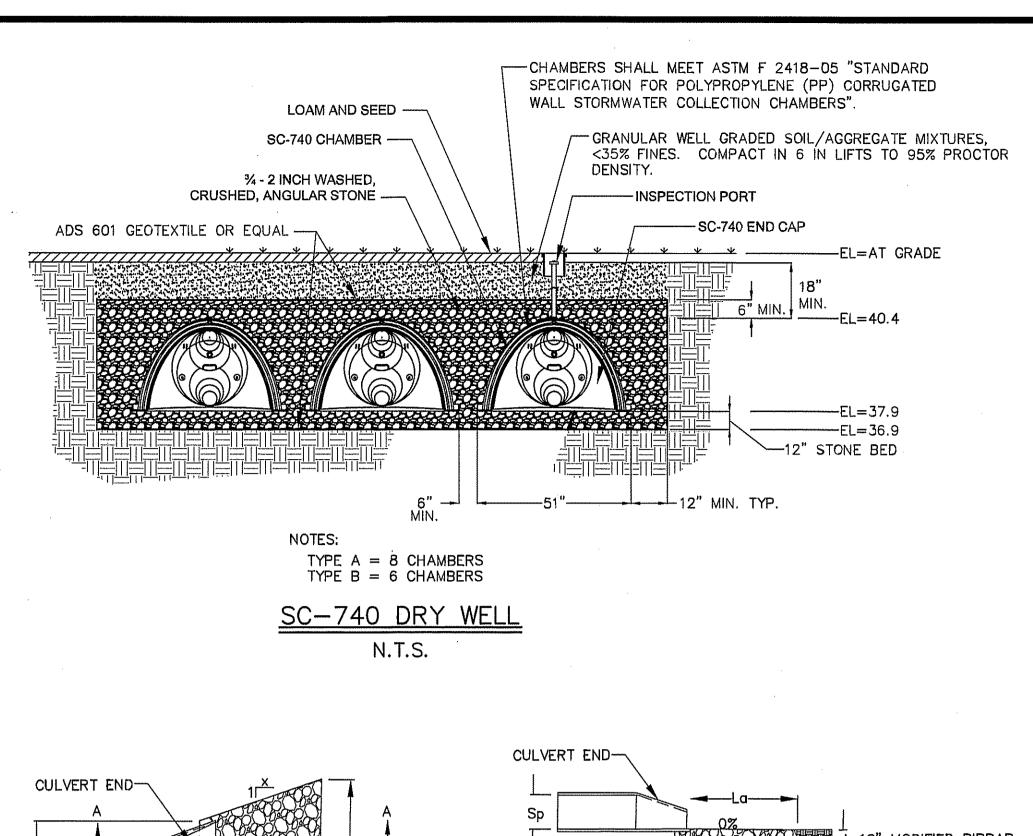

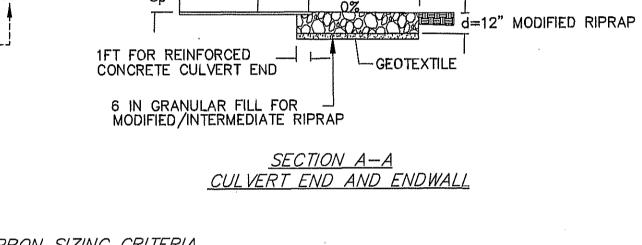

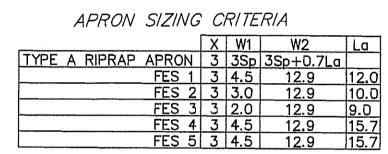


#### RAP OUTLET PROTECTION (TYPE A) N.T.S.


1FT FOR REINFORCED

CONCRETE CULVERT END


CULVERT END PLAN VIEW

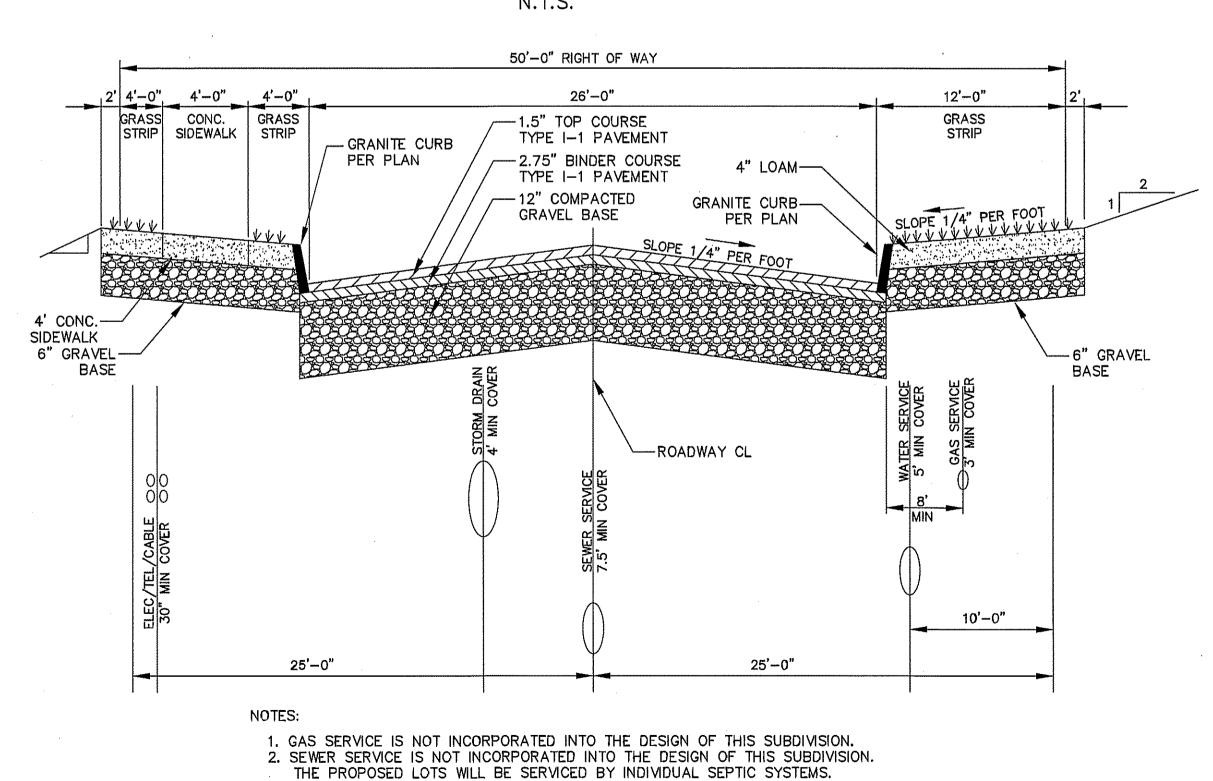


ROADWAY VALVE BOX & COVER COUNTRY FINISH GRADE AS ROAD SURFACE -PAVEMENT AS REQUIRED OR DIRECTED -REQUIRED OR DIRECTED ANCHORING TEE W/6" TEE (RESTRAINED MJ)-EXISTING GROUND -STREET MAIN ----- BACKFILL COMPACTED IN 1FT. BACKFILL -MATCH STREET COMPACTED IN 1FT. LMAIN NOTE: 5'-0" MIN. COVER (TYP.) 6" MIN. 3/4"— CRUSHED STONE BACKFILL MATERIAL SHALL CONSIST OF EXCAVATED MATERIAL AND/OR GRAVEL BORROW AS DIRECTED BY THE TYPICAL WATER MAIN TRENCH DETAIL

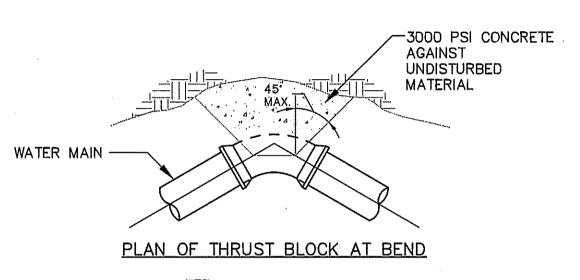


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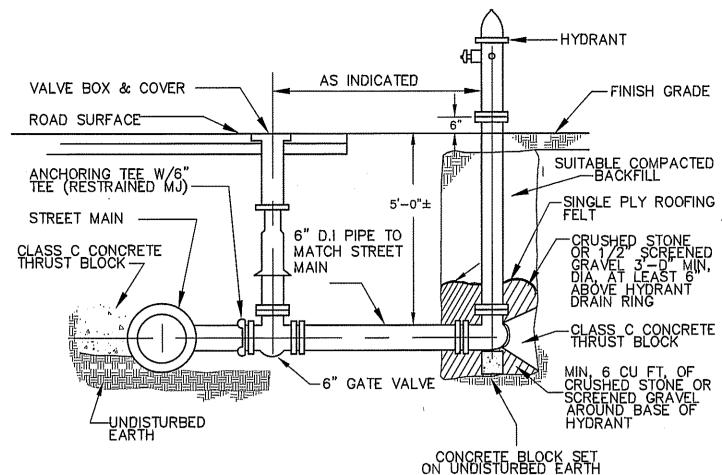


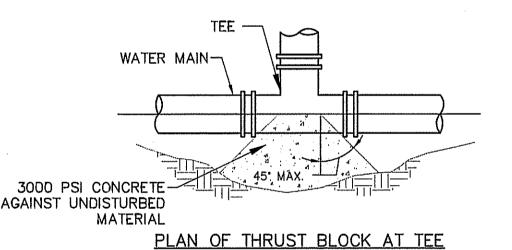

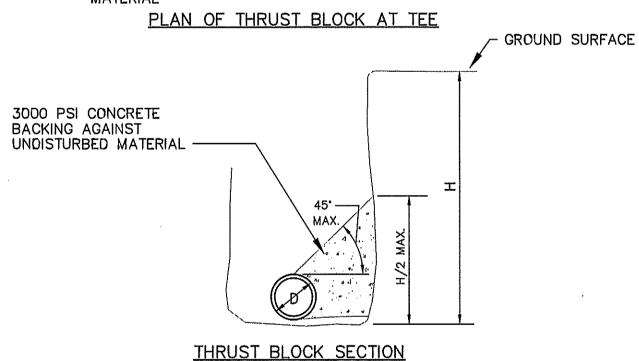
#### WATER MAIN THRUST BLOCK DETAIL N.T.S.

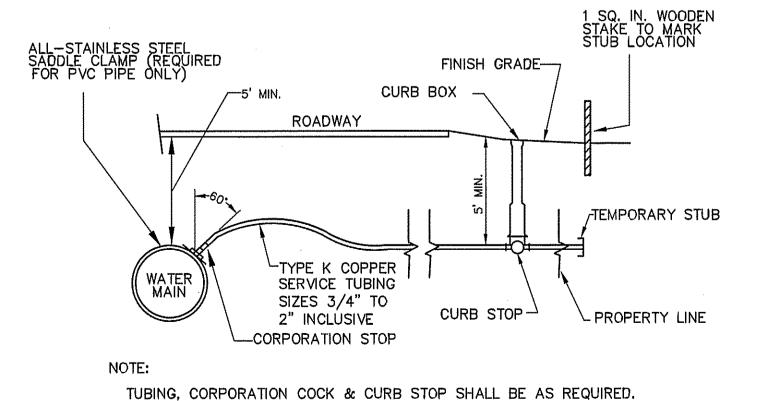


WATER SERVICE DETAIL N.T.S.



#### HYDRANT CONNECTION DETAIL N.T.S.

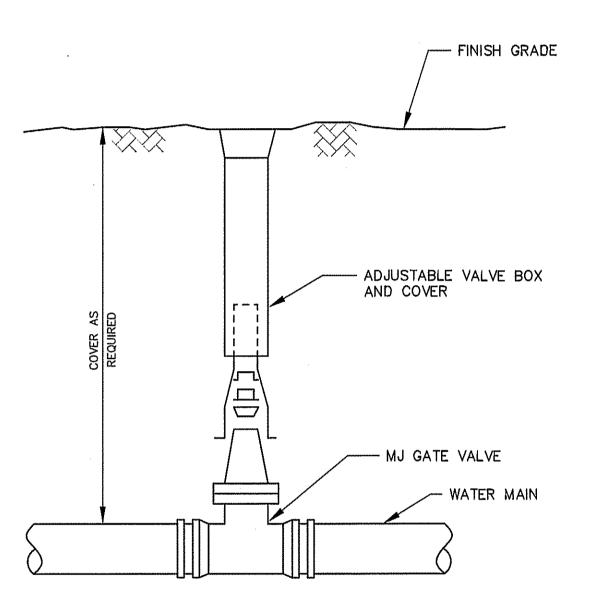

BURIED GATE VALVE DETAIL N.T.S.

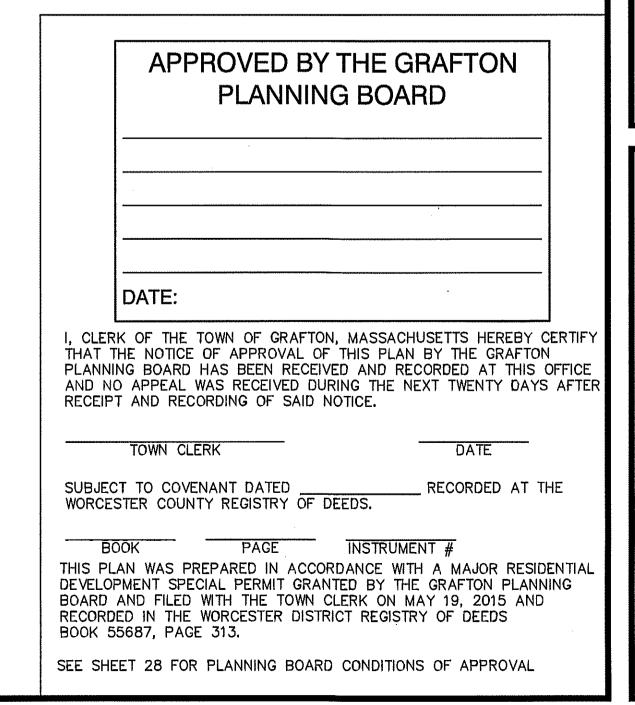

THESE PLANS WERE PREPARED FO THE PURPOSE OF OBTAINING STATE AND LOCAL PERMITS AND ARE NOT INTENDED TO BE USED AS CONSTRUCTION DOCUMENTS.

PREPARED FOR: BULL MEADOW, LLC. 2 RACHEL ROAD BOYLSTON, MA 01505					
		4.1			
~					
3	01/09/2017	NO CHANGE			
2	11/22/2016	TOWN COMMENTS			
1	10/11/2016	TOWN COMMENTS			
No.	Date	Revisian			
BRIAN R.  MARCHETTI CIVIL NO. 46279					

McCarty Engineering, Inc. Civil Engineers 42 Jungle Road, Leominster, MA 01453 phone:(978) 534-1318 fax: (978) 840-6907 www.mccartydb.com

Project Name

Estates at Bull Meadow Definitive Plan N. Grafton, MA 01536


> Sheet Title **Construction Details** (3 of 4)

File Name: 066P-CDT03 Date: June 10, 2016 Scale: AS SHOWN

Sheet No. **25** OF 29

MINOR STREET B STANDARD CROSS-SECTION N.T.S.

COMPACTED FILL-- BOTTOM OF DETENTION Boz NON-WOVEN
GEOTEXTILE FABRIC CROSS-SECTION OF ---6" GRAVEL FILTER BLANKET INFILTRATION BASIN EMERGENCY SPILLWAY CONSISTING OF CLEAN COARSE GRAVEL THAN 10% PASSING A #200 SIEVE. N.T.S.

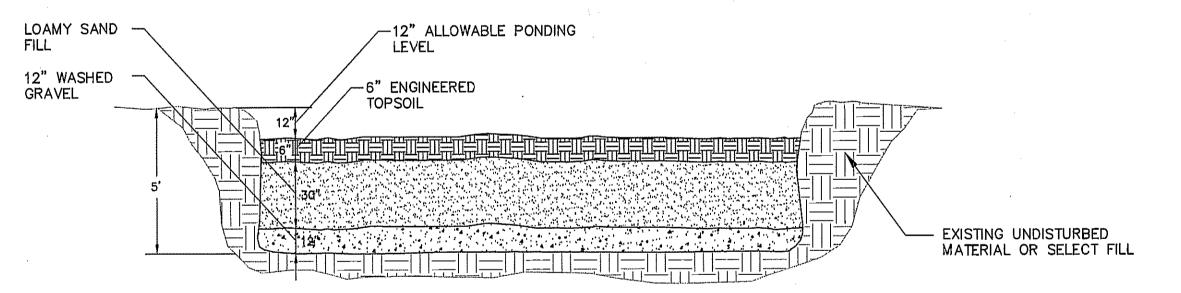

THE FOLLOWING SPECIES ARE RECOMMENDED FOR USE IN RAINGARDENS. MIXTURE OF PLANTINGS SHOULD BE CHOSEN TO MIMIC APPEARANCE OF ADJACENT WETLAND AREAS. THE NUMBER OF PLANTS REQUIRED VARIES WITH THE SIZE OF THE RAIN GARDEN BEING PROPOSED. ONCE THE GRADING OF THE RAINGARDEN IS COMPLETE AND THE FILL IS PLACED WITHIN IT, A LANDSCAPE ARCHITECT SHALL MAKE A SITE INSPECTION TO ADVISE THE CONTRACTOR ON THE NUMBER, SIZE, AND PLACEMENT OF THE PLANTINGS.

TREES:

ACER RUBRUM BETULA NIGRA LARIX LARCINA LIQUIDAMBAR STYRACIFLUA NYSSA SYLVATICA SAMBUCUS CANADENSIS

RED MAPLE RIVER BIRCH EASTERN LARCH SWEETGUM BLACK GUM AMERICAN ELDERBERRY SHRUBS/GROUNDCOVER: AMELANCHIER CANADENSIS ARONIA ARBUTIFOLA CORNUS SERICEA HAMAMELIS VIRGINIANA LLEX GLABRA LLEX VERTICULLATA KALMIA LATIFOLIA VACCINIUM CORYMBOSUM VIBURNUM DENTATUM


RED CHOKEBERRY RED TWIG DOGWOOD WITCH HAZEL INKBERRY WINTERBERRY MOUNTAIN LAUREL HIGHBUSH BLUEBERRY ARROWWOOD

**HERBACEOUS:** 

NEW ENGLAND WETLAND PLANTS - WETLAND SEED MIX ACORUS CALAMUS SWEET FLAG CAREX PENDULA DROOPING SEDGE JOE PYE WEED **EUPATORIUM MACULATUM** IRIS SIBERICA SIBERIAN IRIS BLUE FLAG IRIS IRIS VERSICOLOR CARDNIAL FLOWER LOBELIA CARDINALIS ROYAL FERN OSMUNDA REGALIS CINNAMON FERN OSMUNDA CINNAMOMEA

RAINGARDEN DETAIL

SHADBLOW SERVICEBERRY

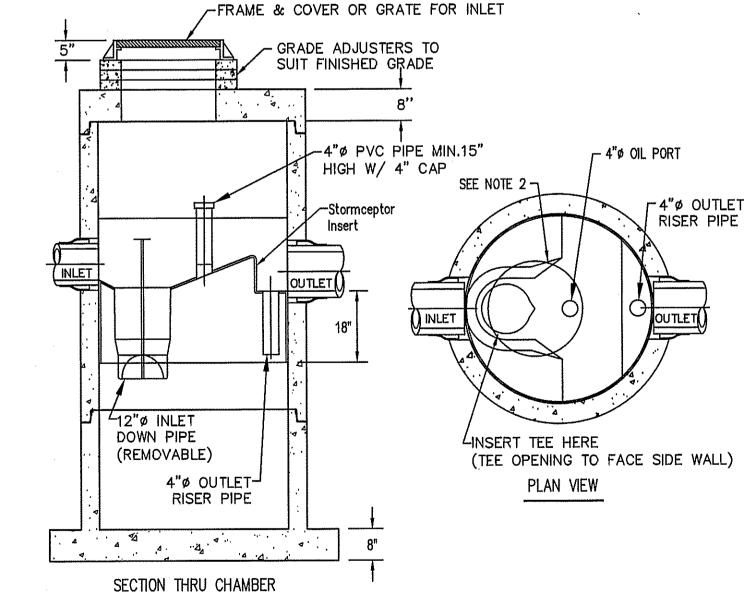

ON THIS DRAWING.


1. THE USE OF FLEXIBLE CONNECTION IS RECOMMENDED AT THE INLET AND OUTLET WHERE APPLICABLE. 2. THE COVER SHOULD BE POSITIONED OVER THE INLET DROP PIPE AND THE OIL PORT 3. THE STORMCEPTOR SYSTEM IS PROTECTED BY ONE OR MORE OF THE FOLLOWING U.S. PATENTS: #4985148, #5498331, #5725760, #5753115, #5849181, #6068765, #6371690. 4. CONTACT A CONCRETE PIPE DIVISION REPRESENTATIVE FOR FURTHER DETAILS NOT LISTED

STC 450 WATER QUALITY UNIT

N.T.S.

∠ 10 MIL PLASTIC LINER - DOUBLE STACKED HAYBALES VARIES - WOODEN STAKES (TYP.)

PLAN

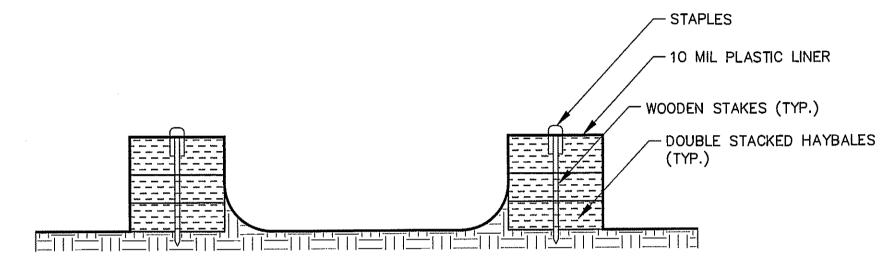

#### SECTION A-A

1. THE CONCRETE WASHOUT AREA SHALL BE INSTALLED PRIOR TO ANY CONCRETE PLACEMENT ON SITE.

- 2. THE CONCRETE WASHOUT AREA WILL BE CONSTRUCTED ABOVE GRADE OR BELOW GRADE AT THE OPTION OF THE CONTRACTOR. THE ACTUAL LAYOUT SHALL BE DETERMINED IN THE FIELD,
- 3. THE CONCRETE WASHOUT AREA SHALL BE CONSTRUCTED AND MAINTAINED IN SUFFICIENT SIZE TO CONTAIN ALL LIQUID AND CONCRETE WASTE GENERATED BY WASHOUT OPERATIONS. THE WASHOUT AREA MUST BE CLEAN OR A NEW WASHOUT AREA MUST BE CONSTRUCTED AND READY FOR USE ONCE THE WASHOUT IS 75% FULL
- 4. THE CONCRETE WASHOUT AREA SHALL BE LOCATED IN THE CONSTRUCTION LAYDOWN AREA.
- 5. PLASTIC LINING MATERIAL SHALL BE A MINIMUM OF 10 MIL POLYETHYLENE SHEETING AND SHALL BE FREE OF HOLES, TEARS, OR OTHER DEFECTS THAT COMPORMISE THE IMPERMEABILITY OF THE MATERIAL.
- 6. WHEN THE CONCRETE WASHOUT AREA IS NO LONGER REQUIRED FOR WORK, THE HARDENED CONCRETE AND MATERIAL USED TO CONSTRUCT WASHOUT AREA SHALL BE REMOVED AND DISPOSED OF AT AN APPROVED WASTE SITE.
- 7. WHEN THE CONCRETE WASHOUT AREA IS REMOVED, THE DISTURBED AREA SHALL BE SEEDED AND MULCHED OR OTHERWISE STABILIZED IN A MANNER APPROVED BY THE ENGINEER.

CONCRETE WASHOUT AREA N.T.S.

> APPROVED BY THE GRAFTON PLANNING BOARD DATE:

CLERK OF THE TOWN OF GRAFTON, MASSACHUSETTS HEREBY CERTIFY THAT THE NOTICE OF APPROVAL OF THIS PLAN BY THE GRAFTON PLANNING BOARD HAS BEEN RECEIVED AND RECORDED AT THIS OFFICE AND NO APPEAL WAS RECEIVED DURING THE NEXT TWENTY DAYS AFTER RECEIPT AND RECORDING OF SAID NOTICE.

TOWN CLERK SUBJECT TO COVENANT DATED WORCESTER COUNTY REGISTRY OF DEEDS.

DATE RECORDED AT THE

INSTRUMENT # PAGE

THIS PLAN WAS PREPARED IN ACCORDANCE WITH A MAJOR RESIDENTIAL DEVELOPMENT SPECIAL PERMIT GRANTED BY THE GRAFTON PLANNING BOARD AND FILED WITH THE TOWN CLERK ON MAY 19, 2015 AND RECORDED IN THE WORCESTER DISTRICT REGISTRY OF DEEDS BOOK 55687, PAGE 313.


SEE SHEET 28 FOR PLANNING BOARD CONDITIONS OF APPROVAL

THESE PLANS WERE PREPARED FO THE PURPOSE OF OBTAINING STATE AND LOCAL PERMITS AND ARE NOT INTENDED TO BE USED AS CONSTRUCTION DOCUMENTS.

NOT FOR CONSTRUCTI

PREPARED FOR: BULL MEADOW, LLC. 2 RACHEL ROAD BOYLSTON, MA 01505

3 01/09/2017 TOWN COMMENTS 2 11/22/2016 TOWN COMMENTS 1 |10/11/2016| TOWN COMMENTS

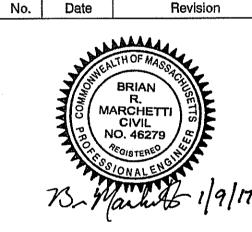

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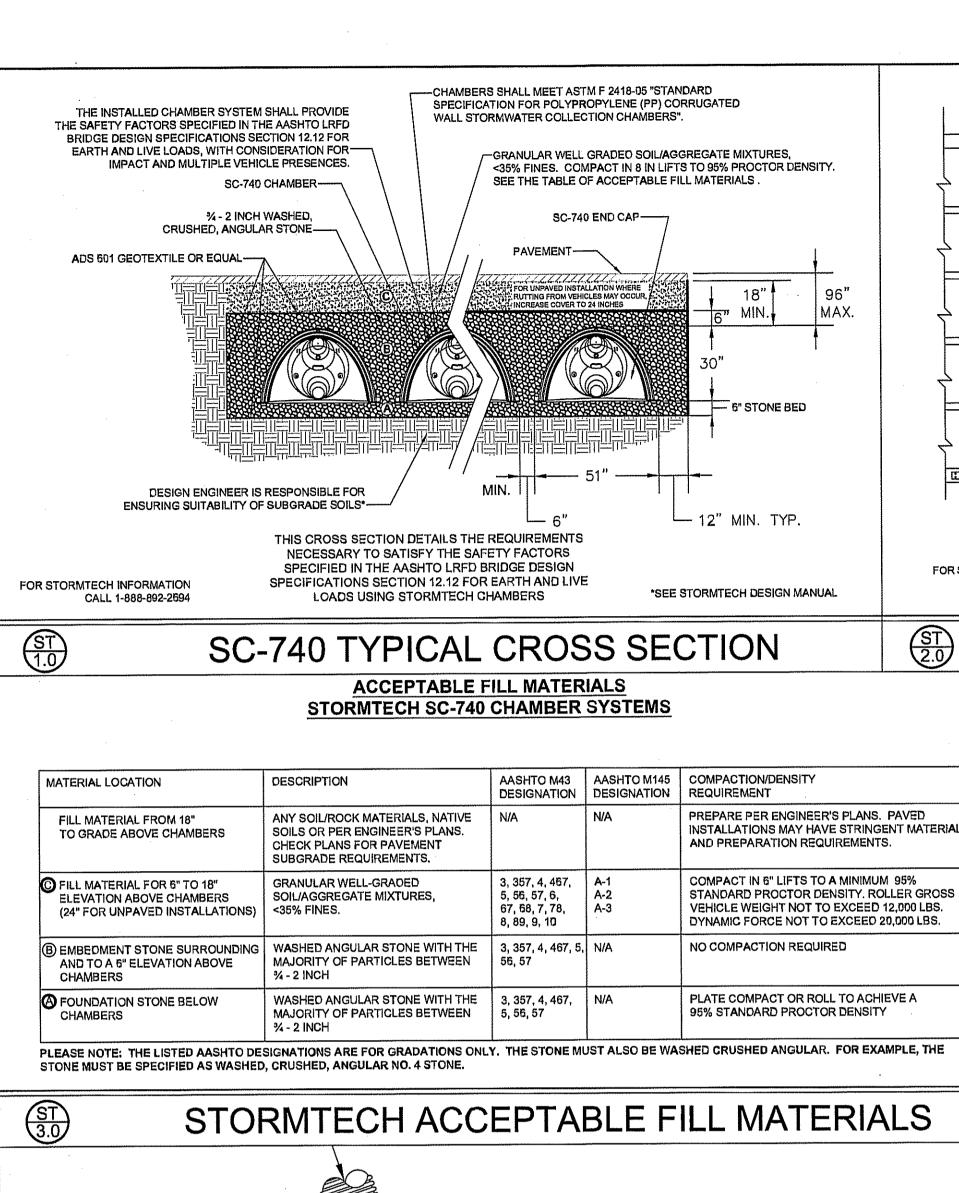
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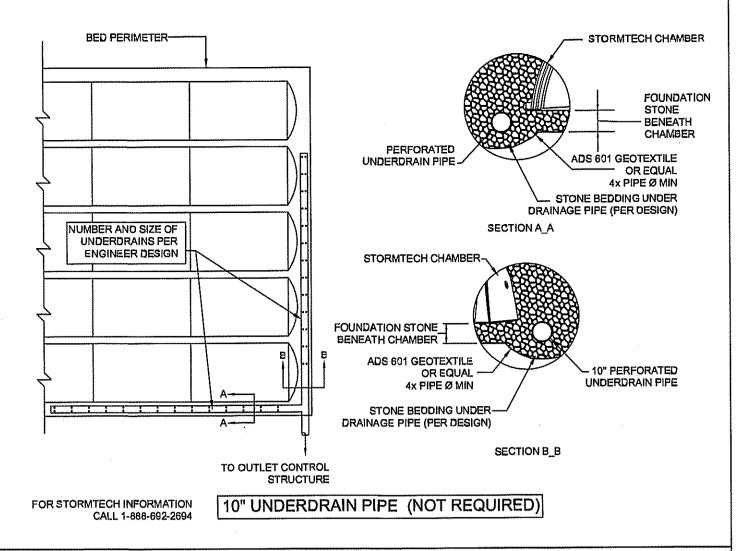
Estates at Bull Meadow Definitive Plan N. Grafton, MA 01536


> Construction Details (4 of 4)

File Name: 066P-CDT04 Date: June 10, 2016 Scale: AS SHOWN

Sheet No.





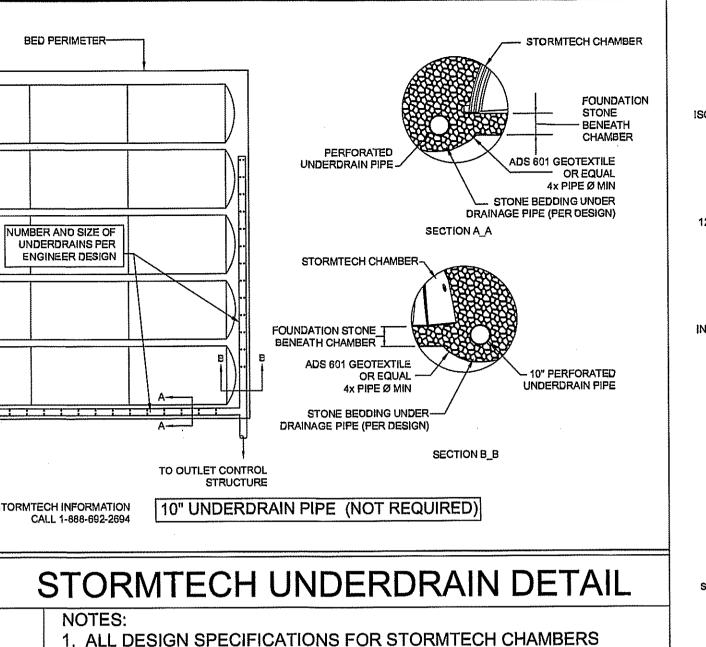

SHALL BE IN ACCORDANCE WITH THE STORMTECH DESIGN MANUAL.

2. THE INSTALLATION OF STORMTECH CHAMBERS SHALL BE IN

3. THE CONTRACTOR IS ADVISED TO REVIEW AND UNDERSTAND

THE INSTALLATION INSTRUCTIONS PRIOR TO BEGINNING SYSTEM

ACCORDANCE WITH THE LATEST STORMTECH INSTALLATION

WWW.STORMTECH.COM TO RECEIVE A COPY OF THE LATEST


4. CHAMBERS SHALL MEET THE DESIGN REQUIREMENTS AND


SAFETY FACTORS SPECIFIED IN SECTION 12.12 OF THE LATEST


EDITION OF THE AASHTO LRFD BRIDGE DESIGN SPECIFICATIONS.

INSTALLATION. CALL 1-888-892-2694 OR VISIT

STORMTECH INSTALLATION INSTRUCTIONS.

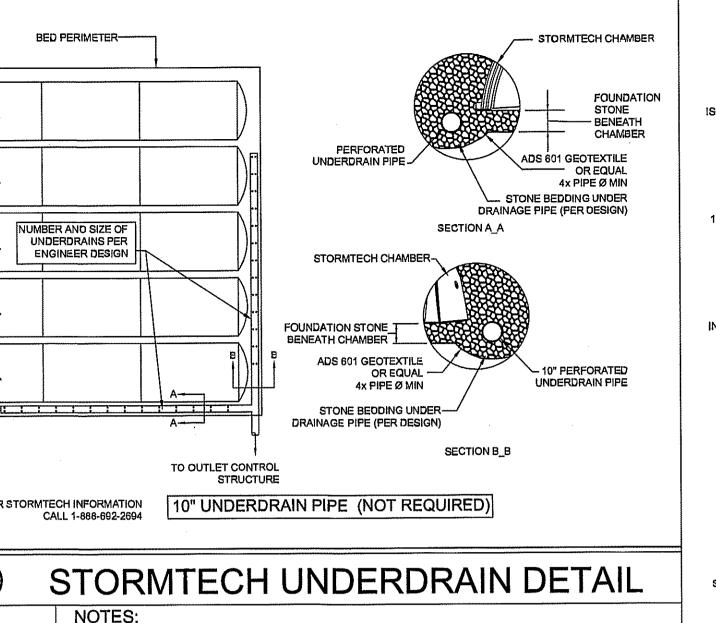

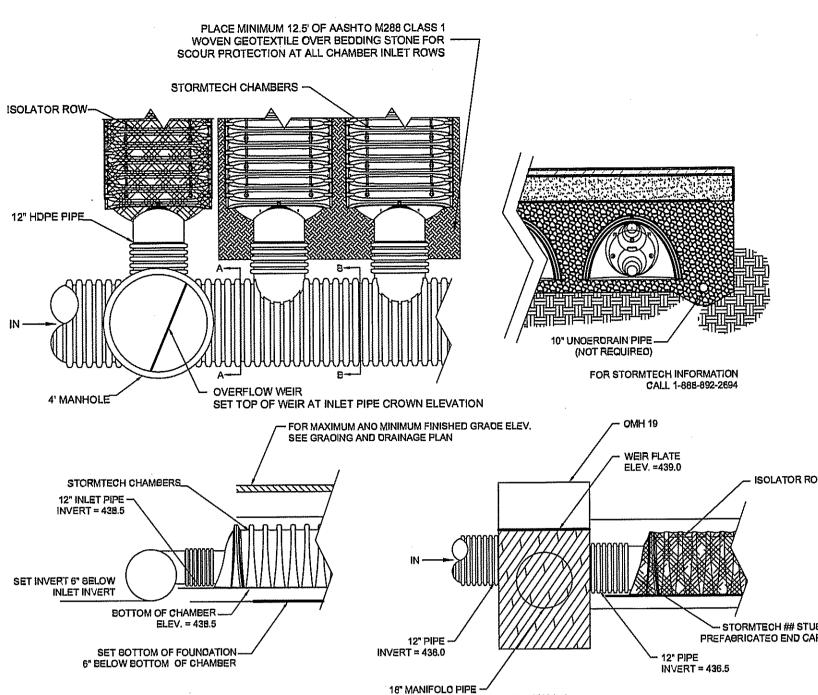

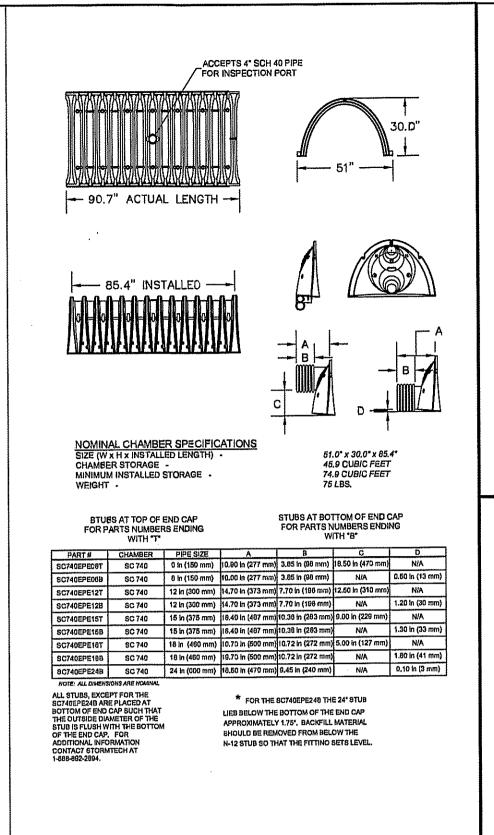

# STORMTECH ELEVATIONS


SECTION A\_A

DMH 12

DMH 19 -

SEE SHEET 28 FOR PLANNING BOARD CONDITIONS OF

WEIR PLATE ---

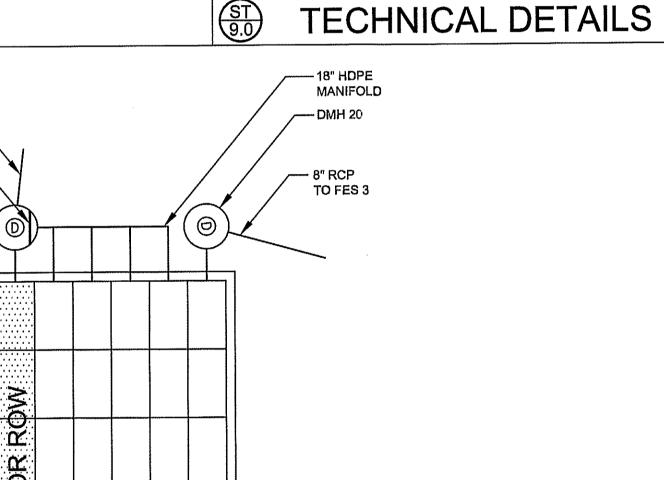

PROJECT NAME This drawing was prepared to support the design engineer for the proposed conversion. It is the ultimete responsibility of the design engineer to essure that the stormwater system's design is in full compliance with all applicable laws and regulations. It is the design engineer's responsibility to ensure that the StormTech products are

engineer is responsible for eil design decisions.			
REVISIONS	DATE		

designed in accordence with

StormTech minimum requirements

StormTech LLC does not approve plans

sizIng, or system designs. The design

TOWN COMMENTS

### **DRAWING TITLE**


Infiltration Basin Details

STORMTECH SC-740 CHAMBER DETAIL SHEET SPECIFICATIONS LOADS SHALL BE CALCULATED IN ACCORDANCE WITH SECTION 3 AND SHALL CHECKED BY BRM DRAWN BY JLL SCALE DRAWING NO. 10/11/201B 27 of 29

SECTION B\_B


FLOOR BOX FRAME AND LID W/S.S. CAP SCREW LID CLOSURE INSPECTION PORT WITH SCREW-IN CAP - CLASS "C" CONCRETE OR LANDSCAPE AASHTO M288 CLASS 2 NON-WOVEN GEOTEXTILE 4" PVC RISER INSPECTION PORT TO BE SC-740 CHAMBER-ATTACHED THROUGH KNOCK-OUT LOCATED AT CENTER OF CHAMBER AASHTO M288 CLASS 2 NON-WOVEN GEOTEXTILE FOR STORMTECH INFORMATION CALL 1-888-892-2694

STORMTECH INSPECTION PORT DETAIL

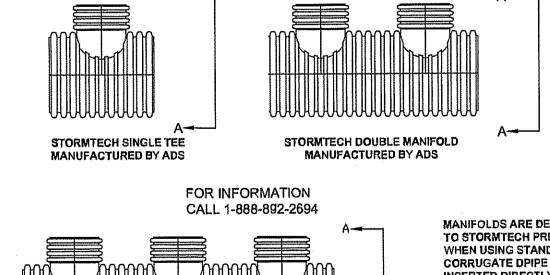

MANIFOLDS ARE DESIGNED TO BE COUPLED TO STORMTECH PREFABRICATED END CAPS. WHEN USING STANDARD END CAPS, CORRUGATE DPIPE UP TO 18 INCHES CAN BE INSERTED DIRECTLY INTO THE END CAP. FOR 24" INLET PIPES, A CORRUGATED TO SMOOTH

**SECTION VIEW A-A** 

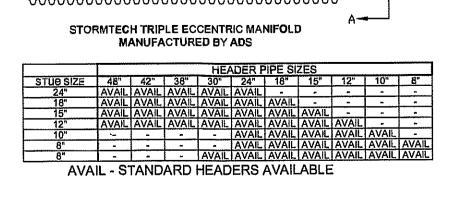

ISOLATOR ROW

-STORMTECH CHAMBERS

ADS MANIFOLD DETAILS

STORMTECH SC-740 CHAMBER LAYOUT

UNDERGROUND INFILTRATION BASIN (SC-740 - 40 CHAMBERS)

SCALE: 1"=10'

INCLUDE H20 DESIGN TRUCK, IMPACT FACTOR, MULTIPLE PRESENCE, AND LANE LOAD.

**GENERAL NOTES:** 

APPROVAL

CHAMBERS SHALL MEET THE DESIGN REQUIREMENTS AND SAFETY FACTORS SPECIFIED IN

SECTION 12.12 OF THE LATEST EDITION OF THE AASHTO LRFD BRIDGE DESIGN

**COVER ENTIRE ROW WITH** - AASHTO M288 CLASS 2 NON-WOVEN GEOTEXTILE OR EQUAL SC-740--8' WIDE STRIP **NSPECTION PORT** SC-310--5' WIDE STRIP BY DESIGN ENGINEER - STORMTECH ENDCAP MANHOLE

STORMTECH PREFABRICATED FOR STORMTECH INFORMATION STORMTECH ISOLATOR™ ROW MANIFOLD DETAIL

MANHOLE WITH-

PLACE MINIMUM 12.5' OF AASHTO M288

BEDDING STONE FOR SCOUR PROTECTION

BY DESIGN

ENGINEER

CLASS 1 WOVEN GEOTEXTILE OVER

AT ALL CHAMBER INLET ROWS

**OVERFLOW WEIR** 

HEADER ---

AASHTO M288 CLASS 1 WOVEN GEOTEXTILE OR EQUAL BETWEEN FOUNDATION STONE AND CHAMBERS

FOR STORMTECH INFORMATION CALL 1-888-892-2694 SC-310--4' WIDE STRIP

STORMTECH ISOLATOR™ ROW DETAIL

#### STORMWATER MANAGEMENT OPERATION & MAINTENANCE PLAN:

1. PARTY RESPONSIBLE FOR OPERATION AND MAINTENANCE:

DURING THE CONSTRUCTION OF THE PROJECT, THE PROPERTY OWNER AND SUBCONTRACTORS ARE RESPONSIBLE FOR THE MAINTENANCE AND OPERATION OF THE PROPOSED SWM COLLECTION SYSTEM INCLUDING DEEP SUMP CATCH BASINS, WATER QUALITY UNITS, SEDIMENT FOREBAYS, ABOVE GRADE INFILTRATION BASINS, A BELOW GRADE INFILTRATION BASIN, VEGETATED SWALES AND RAIN GARDENS. UPON ACCEPTANCE OF THE ROADWAY, THE TOWN OF GRAFTON WILL BE RESPONSIBLE FOR MAINTAINING EVERYTHING PREVIOUSLY MENTIONED, EXCEPT THE RAIN GARDENS, WHICH WILL BE MAINTAINED BY THE PROPERTY OWNER OF THE LOT.

2. INSPECTION AND MAINTENANCE SCHEDULE:

THE TABLE OUTLINES THE INSPECTION AND MAINTENANCE SCHEDULE FOR THE VARIOUS ELEMENTS OF THE SWM SYSTEM.

SWM ELEMENT INS	PECTION/MAINTENANCE TASK	FREQUENCY
SWALE	INSPECT SLOPES REMOVE SEDIMENT	MONTHLY ANNUALLY
CATCH BASINS	INSPECT STRUCTURE REMOVE SEDIMENT	MONTHLY QUARTERLY
SEDIMENT FOREBAY	INSPECT STRUCTURE REMOVE SEDIMENT	MONTHLY QUARTERLY
WATER QUALITY UNIT	INSPECT STRUCTURE REMOVE SEDIMENT	MONTHLY QUARTERLY
ABOVE GRADE INFILTRATION BASIN		ANNUALLY BIANNUALLY
BELOW GRADE INFILTRATION BASIN		ANNUALLY BIANNUALLY
RAIN GARDENS	INSPECT STRUCTURE CLEAN SYSTEM/MOW MULCH/FERTILIZE	ANNUALLY MONTHLY ANNUALLY

3. ROUTINE AND NON-ROUTINE MAINTENANCE TASKS DETAILS:

#### WATER QUALITY UNITS AND DEEP SUMP CATCH BASINS

- INLETS / MANHOLES SHOULD BE CLEANED A MINIMUM OF FOUR TIMES PER YEAR AND INSPECTED MONTHLY.
- ALL SEDIMENTS AND HYDROCARBONS SHOULD BE PROPERLY HANDLED AND DISPOSED, IN ACCORDANCE WITH LOCAL, STATE, AND FEDERAL GUIDELINES AND REGULATIONS.
- STRUCTURES SHOULD BE INSPECTED AND MAINTAINED ACCORDING TO THE MANUFACTURER'S RECOMMENDATION.

#### SEDIMENT FOREBAY

- THE FOREBAY WILL BE CLEANED FOUR TIMES PER YEAR AND INSPECTED MONTHLY.
- ALL SEDIMENTS AND HYDROCARBONS WILL BE PROPERLY HANDLED AND DISPOSED OF OFF-SITE, IN ACCORDANCE WITH LOCAL, STATE, AND FEDERAL GUIDELINES AND REGULATIONS.

#### AT GRADE INFILTRATION BASIN

- ONCE CONSTRUCTED, THE BASIN WILL BE INSPECTED AT A MINIMUM AFTER SEVERAL STORM EVENTS TO CONFIRM DRAINAGE SYSTEM FUNCTIONS, BANK STABILITY, AND VEGETATION GROWTH. PROBLEMS WILL BE ADDRESSED IMMEDIATELY.
- DURING THE FIRST SIX MONTHS OF OPERATION, THE BASIN WILL BE INSPECTED IMMEDIATELY AFTER SIGNIFICANT STORM EVENTS AND CLEANED TO REMOVE SEDIMENT BUILDUP.
- THE INLET PIPE WILL BE INSPECTED AND CLEANED OUT WHERE SEDIMENT APPEARS TO HAVE CLOGGED THE INVERT.
- A STAKE SHALL BE PLACED AT THE BOTTOM OF THE POND WITH MARKS AT 1" INCREMENTS TO MEASURE THE SEDIMENT ACCUMULATION. SEDIMENT WILL BE REMOVED FROM PONDS AT A MINIMUM WHEN ACCUMULATION IS AT 4", BUT AS OFTEN AS NECESSARY, AND AT LEAST DNCE EVERY 10 YEARS.
- AT LEAST TWICE DURING THE GROWING SEASON, THE SIDE SLOPES WILL BE MOWED, AND ACCUMULATED TRASH AND DEBRIS REMOVED.

  ACCUMULATED SEDIMENT IN FOREBAY WILL ALSO BE REMOVED AT THIS TIME

#### BELOW GRADE INFILTRATION BASIN

- ONCE CONSTRUCTED, BASIN WILL BE INSPECTED AT A MINIMUM AFTER SEVERAL STORM EVENTS FOR THE FIRST YEAR AND ANNUALLY THEREAFTER TO CONFIRM DRAINAGE SYSTEM FUNCTIONS AS DESIGNED. PROBLEMS WILL BE ADDRESSED IMMEDIATELY.
- SYSTEM SHALL BE CLEANED AS REQUIRED PER THE MANUFACTURER'S RECOMMENDATIONS.

#### VEGETATED SWALE


- \* ONCE CONSTRUCTED, THE VEGETATED SWALES WILL BE INSPECTED AT A MINIMUM AFTER EACH STORM EVENT DURING THE FIRST YEAR (ESTABLISHMENT PERIOD) TO ENSURE NO WASHOUT HAS OCCURRED. INSPECTIONS SHALL BE MONTHLY THEREAFTER. REPAIR ERODED AREAS AS NEEDED.
- AT LEAST MONTHLY DURING THE GROWING SEASON, THE SIDE SLOPES AND CHANNEL BOTTOM WILL BE MOWED, AND ACCUMULATED TRASH AND DEBRIS REMOVED.
- ANY COLLECTED SAND / SEDIMENT FROM WINTER TIME SANDING AND ROADWAY MAINTENANCE SHALL BE REMOVED ON A YEARLY BASIS.

#### RAIN GARDENS

- ONCE CONSTRUCTED, THE RAIN GARDEN WILL BE INSPECTED AT A MINIMUM AFTER EACH MAJOR STORM EVENT FOR THE FIRST YEAR AND ANNUALLY THEREAFTER TO CONFIRM SYSTEM FUNCTIONS AS DESIGNED. PROBLEMS WILL BE ADDRESSED IMMEDIATELY.
- RAIN GARDENS SHALL BE INSPECTED MONTHLY FOR TRASH REMOVAL.
- BANKS OF THE RAINGARDEN SHALL BE MOWED MONTHLY AT A MINIMUM.
- AT LEAST ONCE A YEAR, RAIN GARDENS SHALL BE MULCHED, FERTILIZED AND PRUNED AND ALL DEAD VEGETATION REMOVED AND DISPOSED OF.

NOT FOR CONSTRUCTION
THESE PLANS WERE PREPARED FOR
THE PURPOSE OF OBTAINING STATE
AND LOCAL PERMITS AND ARE NOT
INTENDED TO BE USED AS
CONSTRUCTION DOCUMENTS.

PREPARED FOR: BULL MEADOW, LLC. 2 RACHEL ROAD BOYLSTON, MA 01505

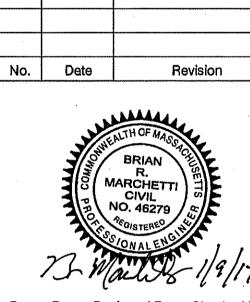

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McCarty Engineering, Inc.
Civil Engineers
42 Jungle Road, Leominster, MA 01453
phone: (978) 534-1318 fax: (978) 840-6907
www.mccartydb.com

Project Name

Estates at Bull Meadow Definitive Plan N. Grafton, MA 01536

Sheet Title
O & M
Plan

Job No: 066
File Name: 066P-NOTES01
Date: January 9, 2017
Scale: NONE

**A** O OF 29

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APPROVED BY THE GRAFTON
PLANNING BOARD

JATE:

I, CLERK OF THE TOWN OF GRAFTON, MASSACHUSETTS HEREBY CERTIFY
THAT THE NOTICE OF APPROVAL OF THIS PLAN BY THE GRAFTON
PLANNING BOARD HAS BEEN RECEIVED AND RECORDED AT THIS OFFICE
AND NO APPEAL WAS RECEIVED DURING THE NEXT TWENTY DAYS AFTER
RECEIPT AND RECORDING OF SAID NOTICE.

TOWN CLERK

SUBJECT TO COVENANT DATED
WORCESTER COUNTY REGISTRY OF DEEDS.

BOOK
PAGE
INSTRUMENT #

THIS PLAN WAS PREPARED IN ACCORDANCE WITH A MAJOR RESIDENTIAL
DEVELOPMENT SPECIAL PERMIT GRANTED BY THE GRAFTON PLANNING
BOARD AND FLIED WITH THE TOWN CLERK ON MAY 19, 2015 AND
RECORDED IN THE WORCESTER DISTRICT REGISTRY OF DEEDS
BOOK 55687, PAGE 313.

SEE SHEET 28 FOR PLANNING BOARD CONDITIONS OF APPROVAL

NOT FOR CONSTRUCTION
THESE PLANS WERE PREPARED FOR
THE PURPOSE OF OBTAINING STATE
AND LOCAL PERMITS AND ARE NOT
INTENDED TO BE USED AS
CONSTRUCTION DOCUMENTS.

PREPARED FOR:
BULL MEADOW, LLC.
2 RACHEL ROAD
BOYLSTON, MA 01505

2 01/09/2017 NO CHANGE
1 11/22/2016 NO CHANGE
No. Dete Revision



Drewn By: Designed By: Checked By: BRM BRM 7376.79

McCarty Engineering, Inc.
Civil Engineers
42 Jungle Road, Leominster, MA 01453
phone: (978) 534-1318 fax: (978) 840-6907
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Project Name

Estates at Bull Meadow Definitive Plan N. Grafton, MA 01536

Conditions of Approval

Joh No: 066

File Name: 066P-COND01

Date: October 11, 2016

Scale: NONE

Sheet No.

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OF 29